Thames Tideway Tunnel Thames Water Utilities Limited

Application for Development Consent

Application Reference Number: WWO10001

Book of Plans


Doc Ref: **2.17**

Albert Embankment Foreshore

APFP Regulations 2009: Regulation **5(2)(k), (o)**





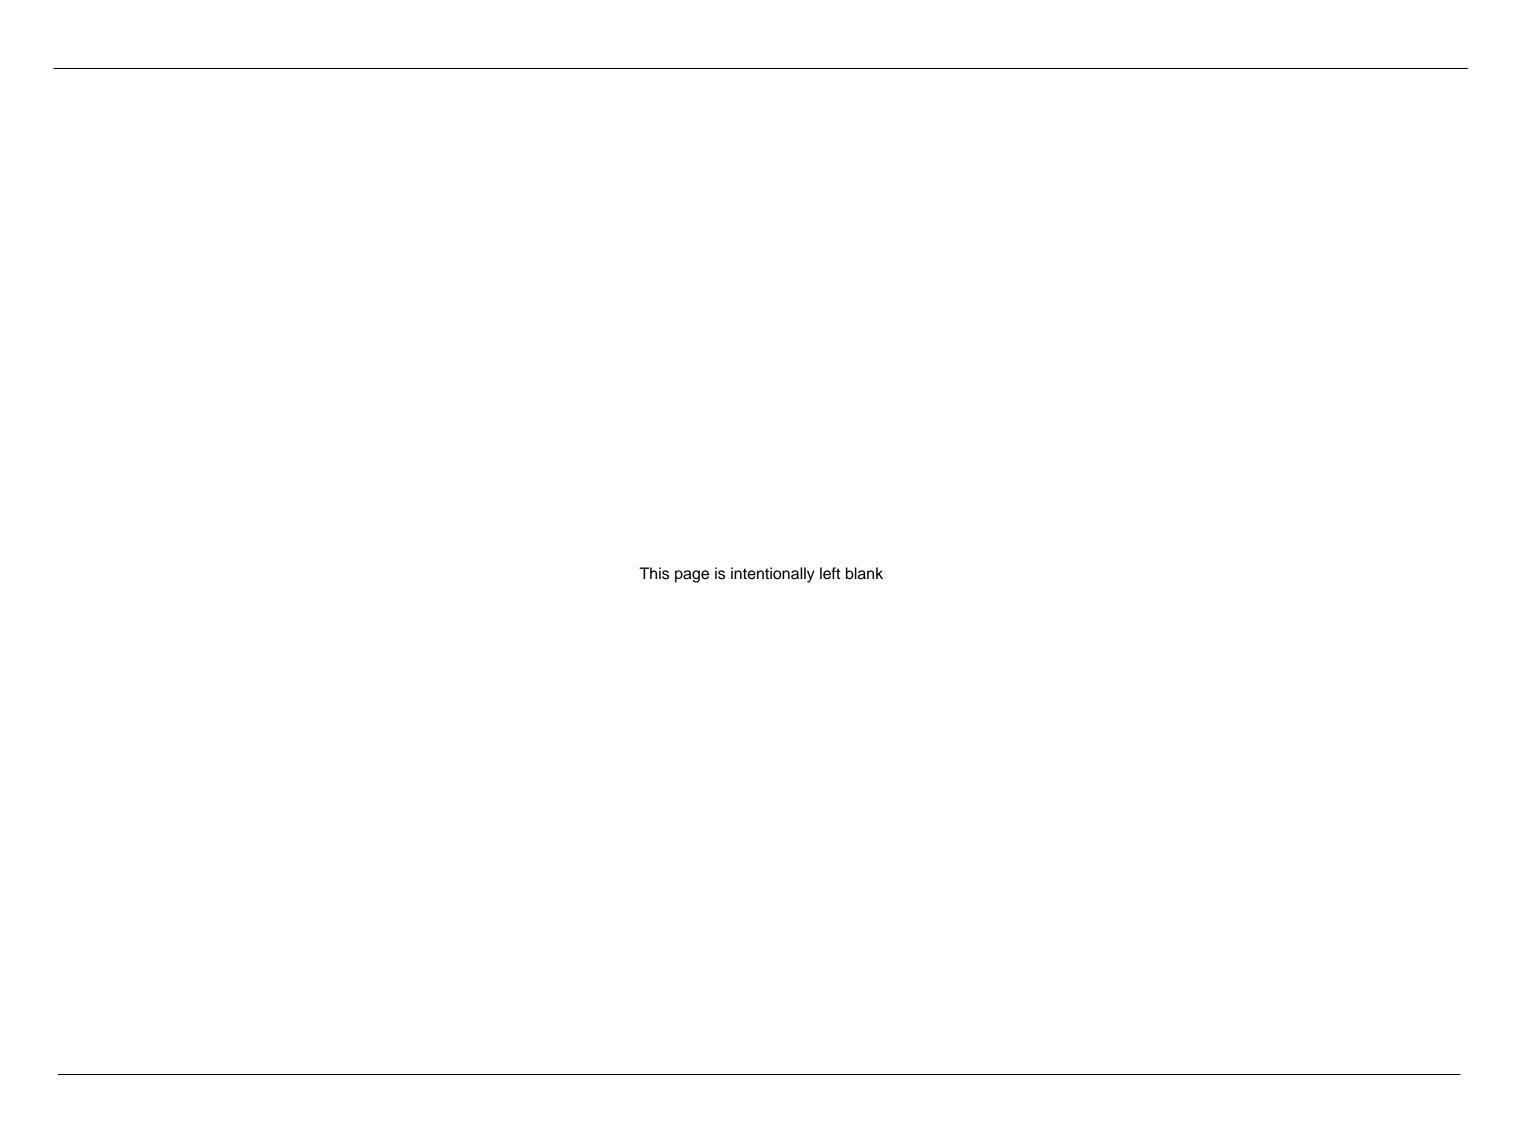

Application for Development Consent: Book of Plans

List of Volumes

Вох	Folder/Volume	Section	Location	Drawing type or site location
		1	Project-wide drawings	Works plan and sections
	1	2	Project-wide drawings	Land acquisition plans
		3	Project-wide drawings	Land plans
		4	Project-wide drawings	Crown and special category land plans
	2	5	Site drawings	Acton Storm Tanks
		6	Site drawings	Hammersmith Pumping Station
		7	Site drawings	Barn Elms
61		8	Site drawings	Putney Embankment Foreshore
		9	Site drawings	Carnwath Road Riverside
	3	10	Site drawings	Dormay Street
		11	Site drawings	King George's Park
		12	Site drawings	Falconbrook Pumping Station
		13	Site drawings	Cremorne Wharf Depot
		14	Site drawings	Chelsea Embankment Foreshore
		15	Site drawings	Kirtling Street
	4	16	Site drawings	Heathwall Pumping Station
		17	Site drawings	Albert Embankment Foreshore
		18	Site drawings	Victoria Embankment Foreshore
		19	Site drawings	Blackfriars Bridge Foreshore
	5	20	Site drawings	Shad Thames Pumping Station
62		21	Site drawings	Chambers Wharf
		22	Site drawings	Earl Pumping Station
		23	Site drawings	Deptford Church Street
	6	24	Site drawings	Greenwich Pumping Station
		25	Site drawings	King Edward Memorial Park Foreshore
		26	Site drawings	Bekesbourne Street
		27	Site drawings	Abbey Mils Pumping Station
		28	Site drawings	Beckton Sewage Treatment Works.
		29	Project-wide drawings	Ventilation columns

This volume is Volume 4


Volume 4


List of contents


Drawing Title	Sheet No.	Drawing number
Section 17: Albert Embankment Foreshore		Drawing named
Location plan		DCO-PP-15X-ALBEF-170001
As existing site features plan		DCO-PP-15X-ALBEF-170002
As existing landscape plan - interception structure		DCO-PP-15X-ALBEF-170003
As existing landscape plan - shaft structure		DCO-PP-15X-ALBEF-170004
Access plan		DCO-PP-15X-ALBEF-170005
Demolition and site clearance	1 of 2	DCO-PP-15X-ALBEF-170006
Demolition and site clearance	2 of 2	DCO-PP-15X-ALBEF-170007
Site works parameter plan		DCO-PP-15X-ALBEF-170008
Site works parameter key plan		DCO-PP-15X-ALBEF-170009
Permanent works layout	1 of 2	DCO-PP-15X-ALBEF-170010
Permanent works layout	2 of 2	DCO-PP-15X-ALBEF-170011
Proposed site features plan		DCO-PP-15X-ALBEF-170012
Proposed landscape plan - interception structure	1 of 2	DCO-PP-15X-ALBEF-170013
Proposed landscape plan - shaft structure	2 of 2	DCO-PP-15X-ALBEF-170014
Section AA	1 of 2	DCO-PP-15X-ALBEF-170015
Section AA	2 of 2	DCO-PP-15X-ALBEF-170016
Section BB		DCO-PP-15X-ALBEF-170017
Section CC		DCO-PP-15X-ALBEF-170018
As existing and proposed west (river) elevation		DCO-PP-15X-ALBEF-170019
As existing and proposed north elevation		DCO-PP-15X-ALBEF-170020
Proposed west (river) elevation - interception structure		DCO-PP-15X-ALBEF-170021
Proposed south elevation - interception structure		DCO-PP-15X-ALBEF-170022
Proposed north elevation - shaft structure		DCO-PP-15X-ALBEF-170023
Proposed west (river) elevation - shaft structure		DCO-PP-15X-ALBEF-170024


^{*} Schedules of associated highway works are located in the *Transport Assessment*


Drawing Title	Sheet No.	Drawing number
Proposed south elevation - shaft structure		DCO-PP-15X-ALBEF-170025
Kiosk design intent		DCO-PP-15X-ALBEF-170026
Typical river wall design intent		DCO-PP-15X-ALBEF-170027
As existing listed structure interface - interception structure		DCO-PP-15X-ALBEF-170028
Proposed listed structure interface - interception structure		DCO-PP-15X-ALBEF-170029
Construction phases - phase 1 Site setup		DCO-PP-15X-ALBEF-170030
Construction phases - phase 2 Shaft construction and tunnelling		DCO-PP-15X-ALBEF-170031
Construction phases - phase 3 Construction of other structures		DCO-PP-15X-ALBEF-170032
Construction phases - phase 4 Site demobilisation		DCO-PP-15X-ALBEF-170033
Highway layout during construction - Option A		DCO-PP-15X-ALBEF-170038
Highway layout during construction - Option B		DCO-PP-15X-ALBEF-170039
Permanent highway layout - Option A		DCO-PP-15X-ALBEF-170040
Permanent highway layout - Option B		DCO-PP-15X-ALBEF-170041

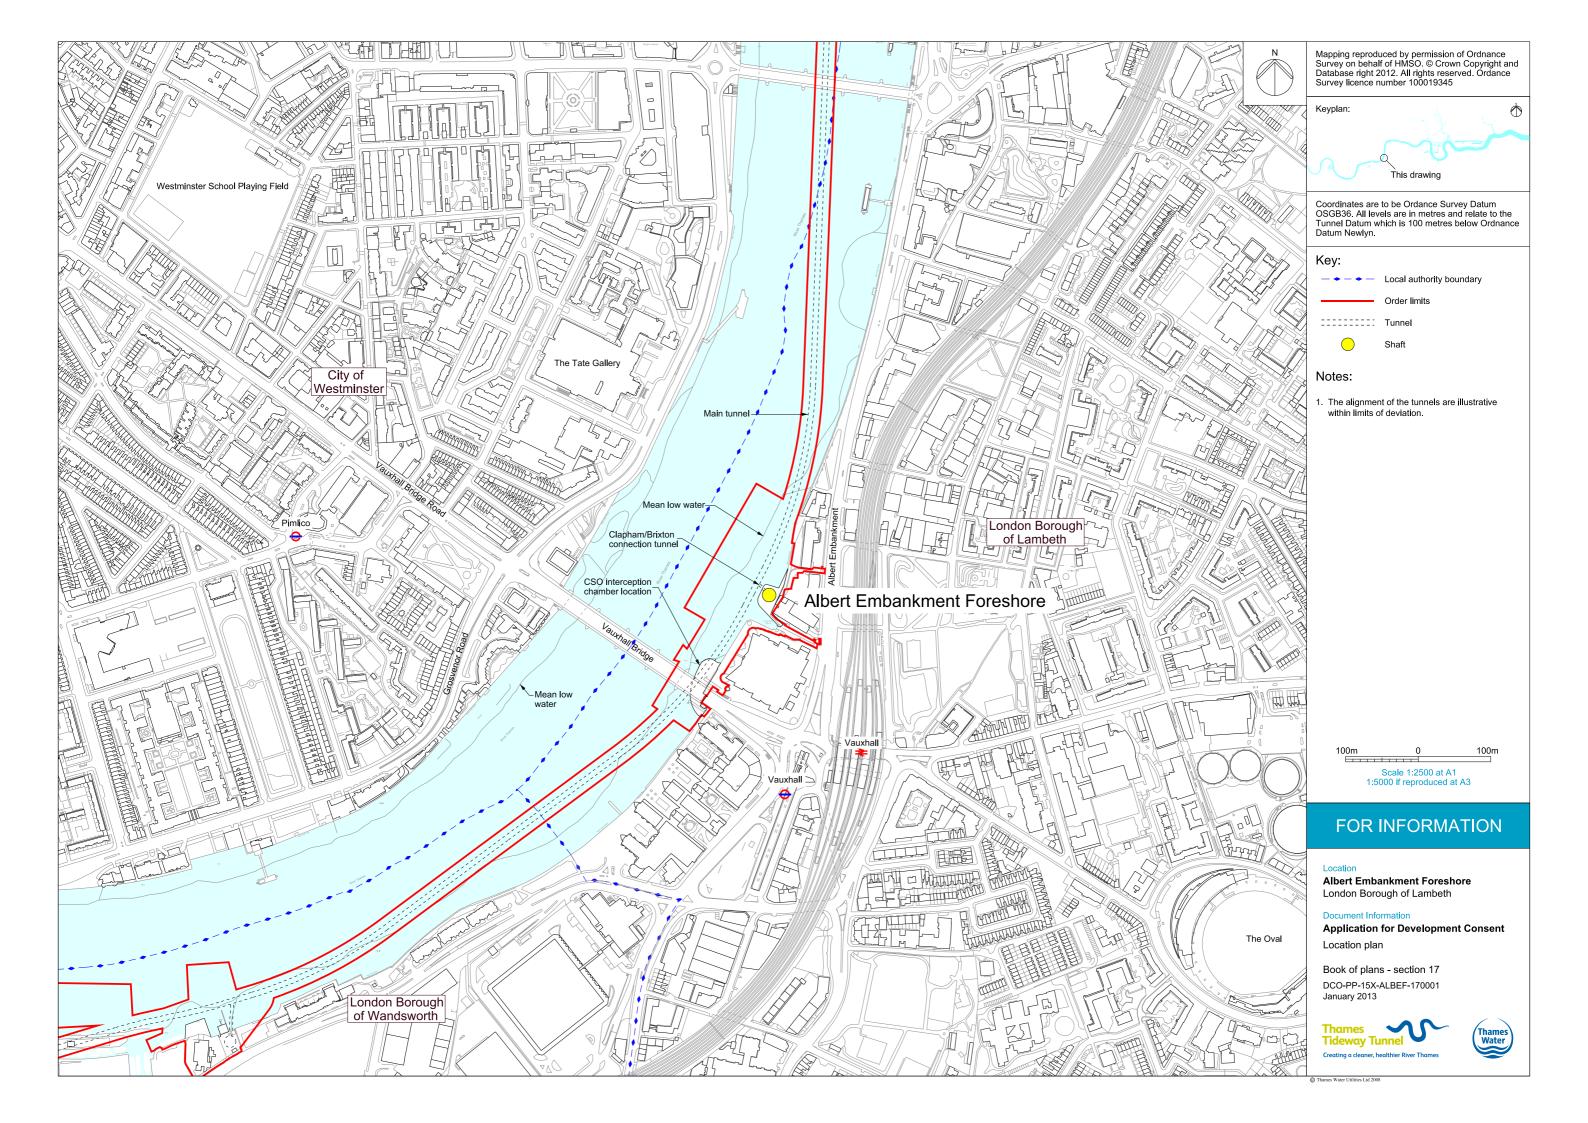


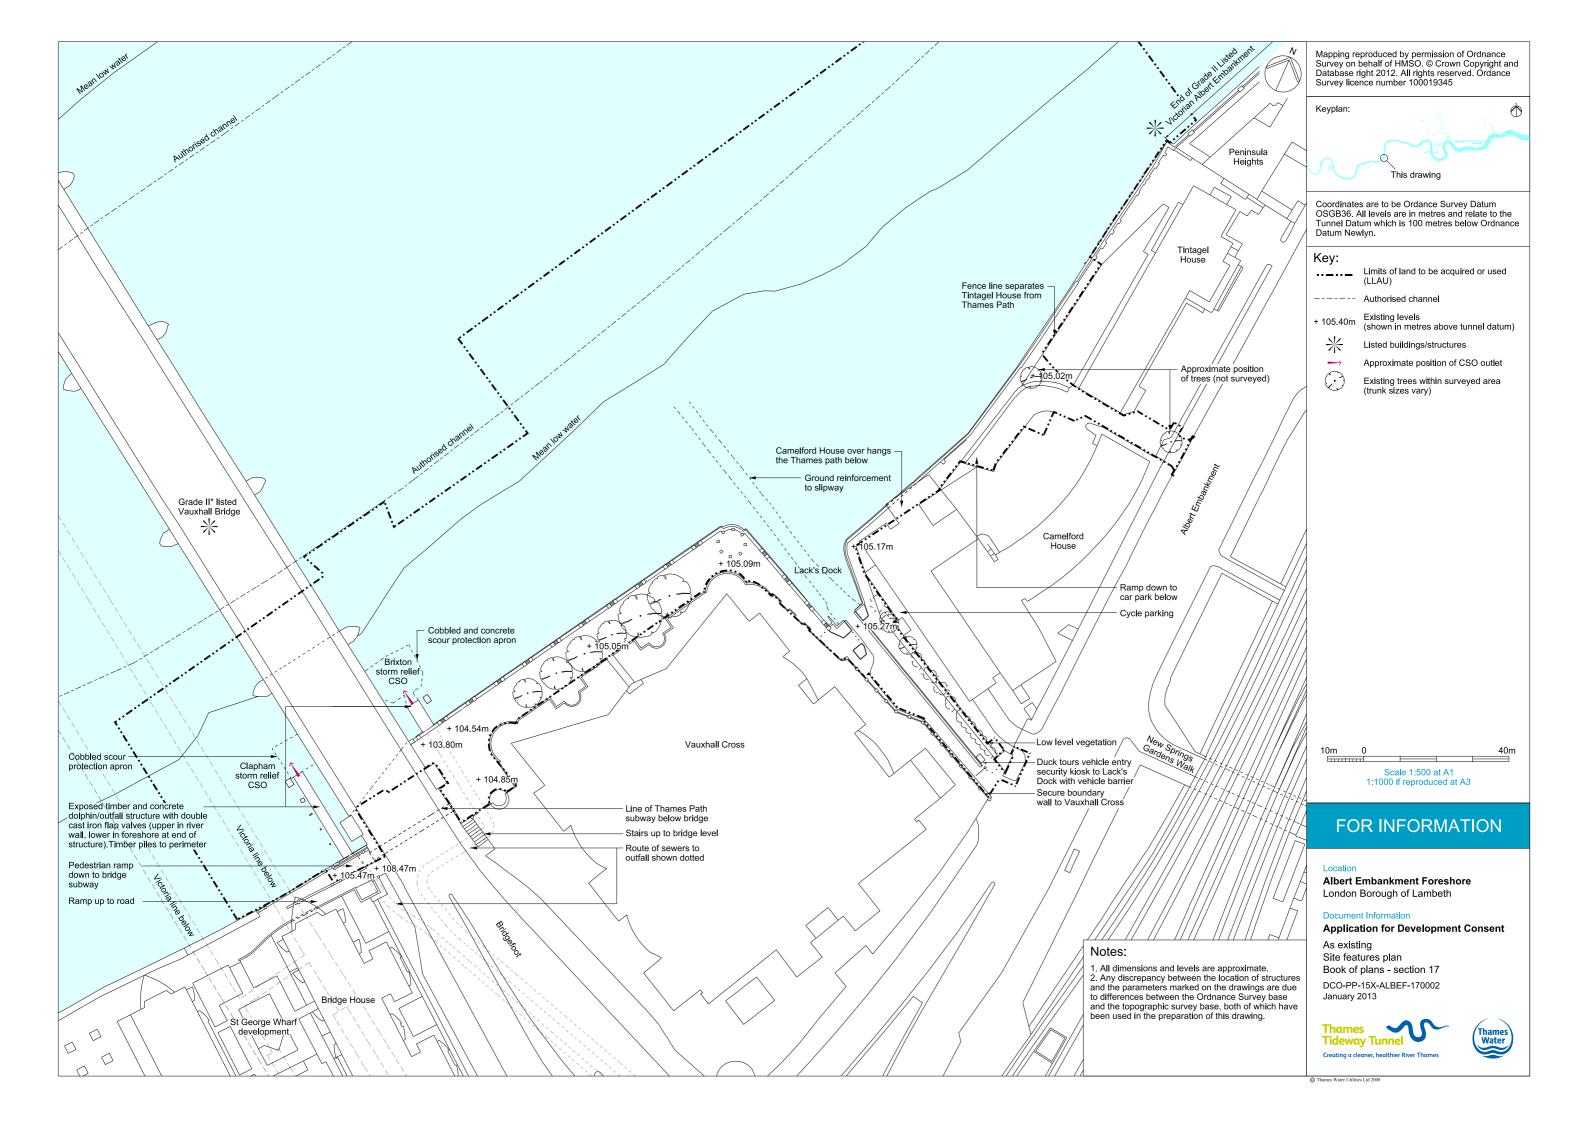


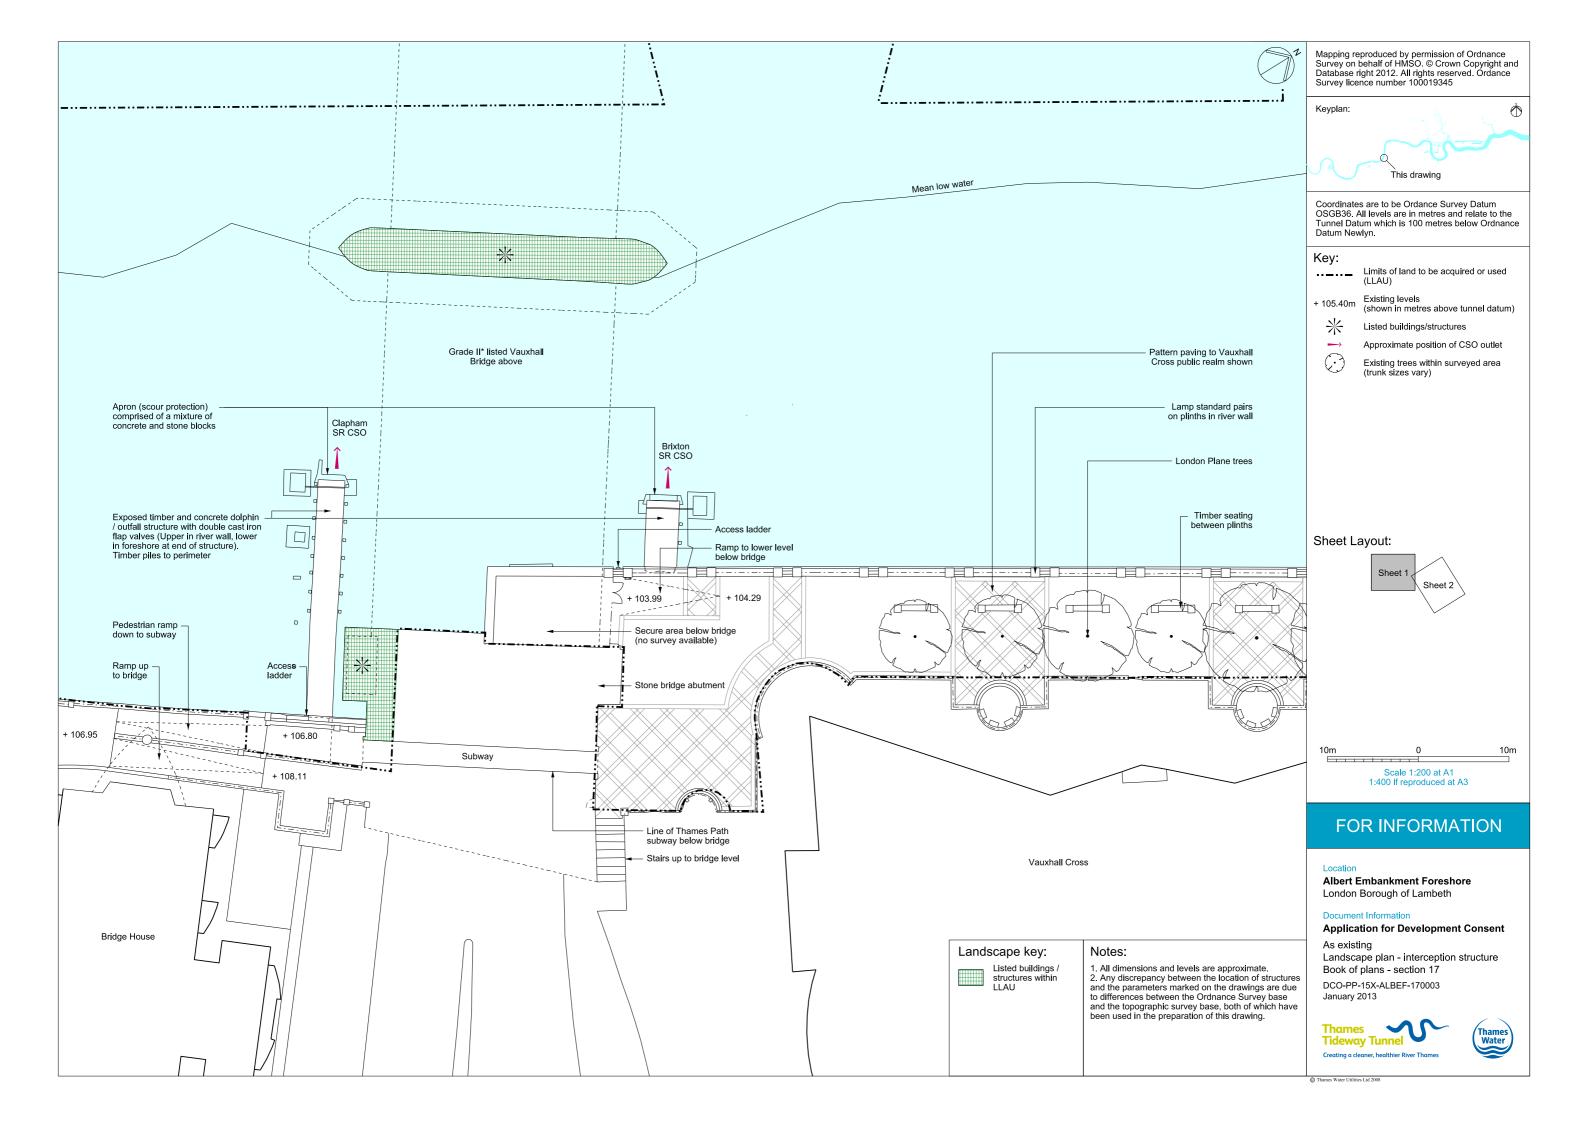


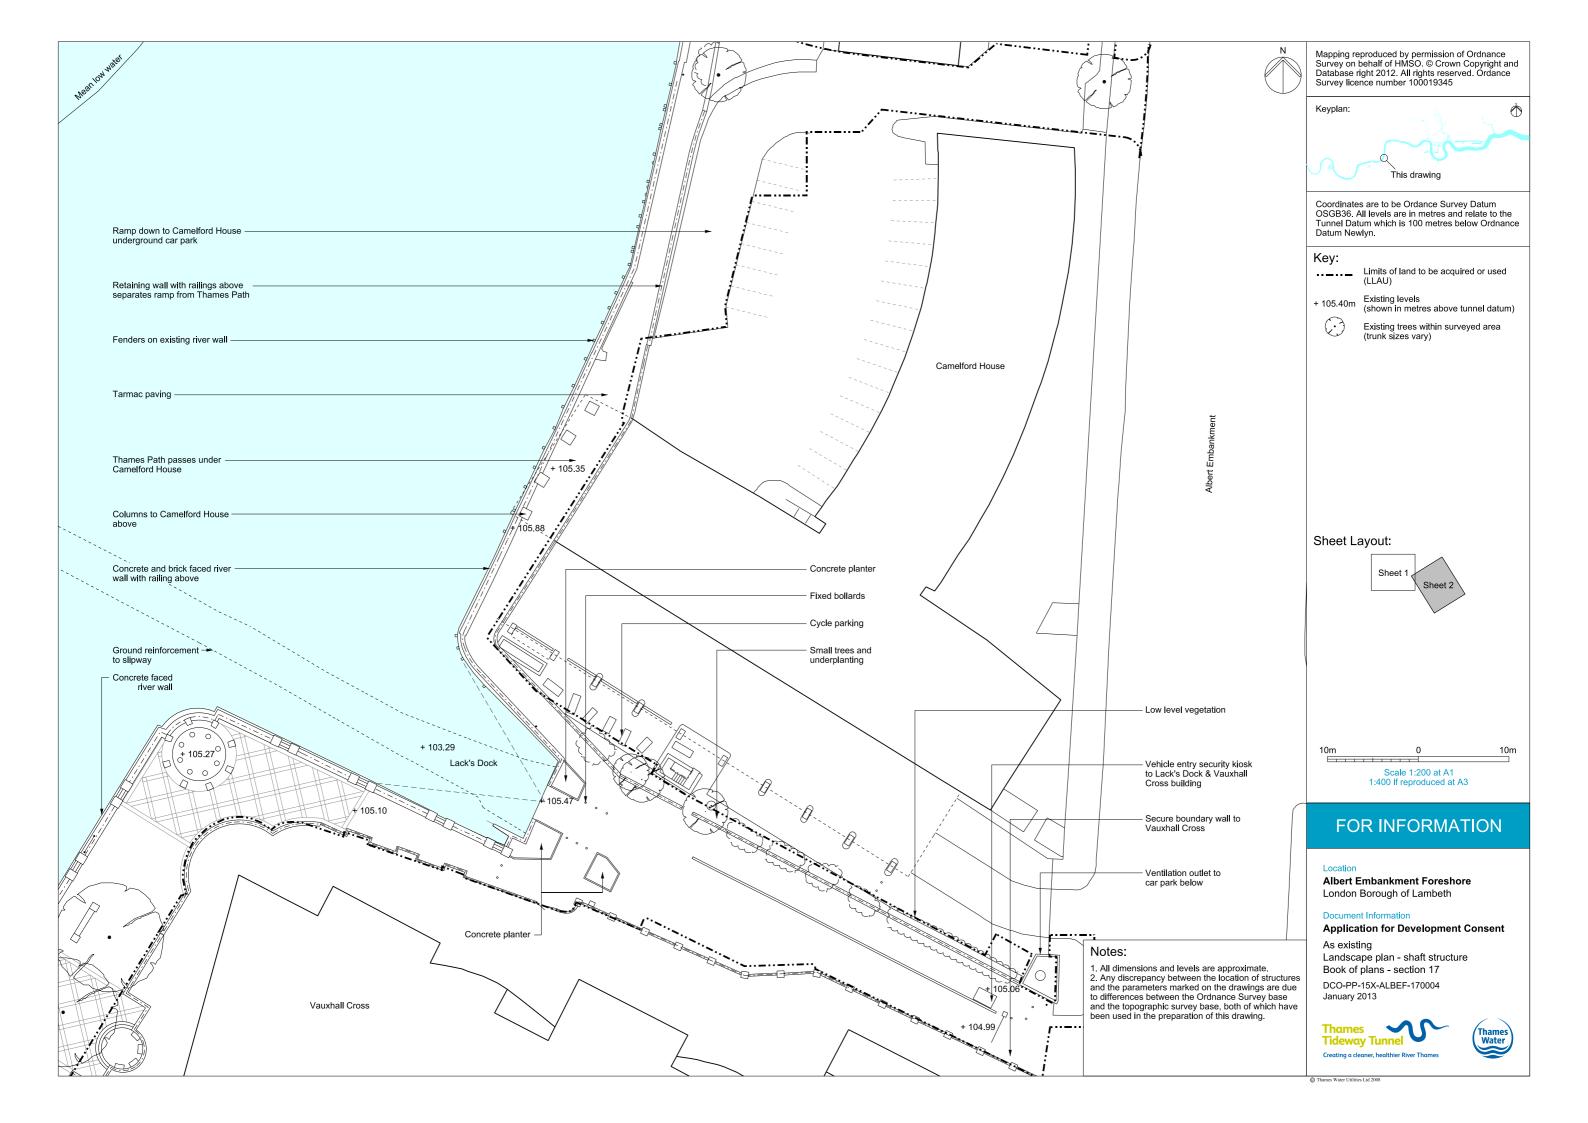

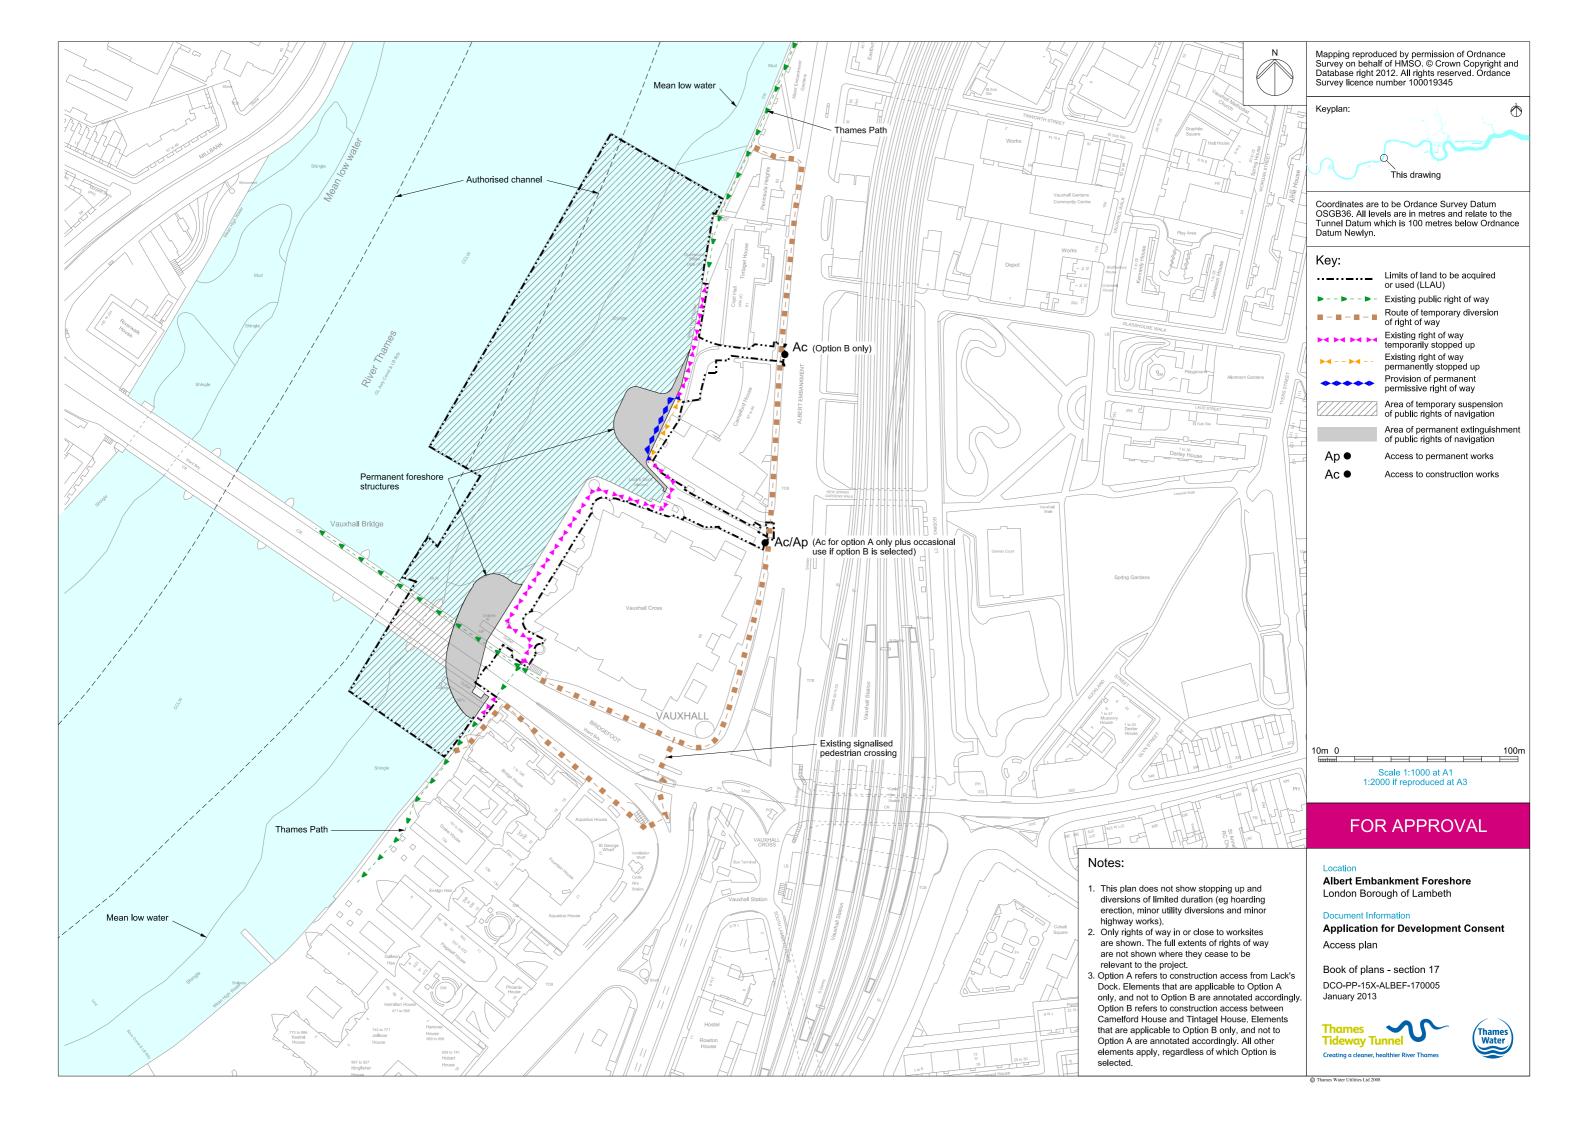


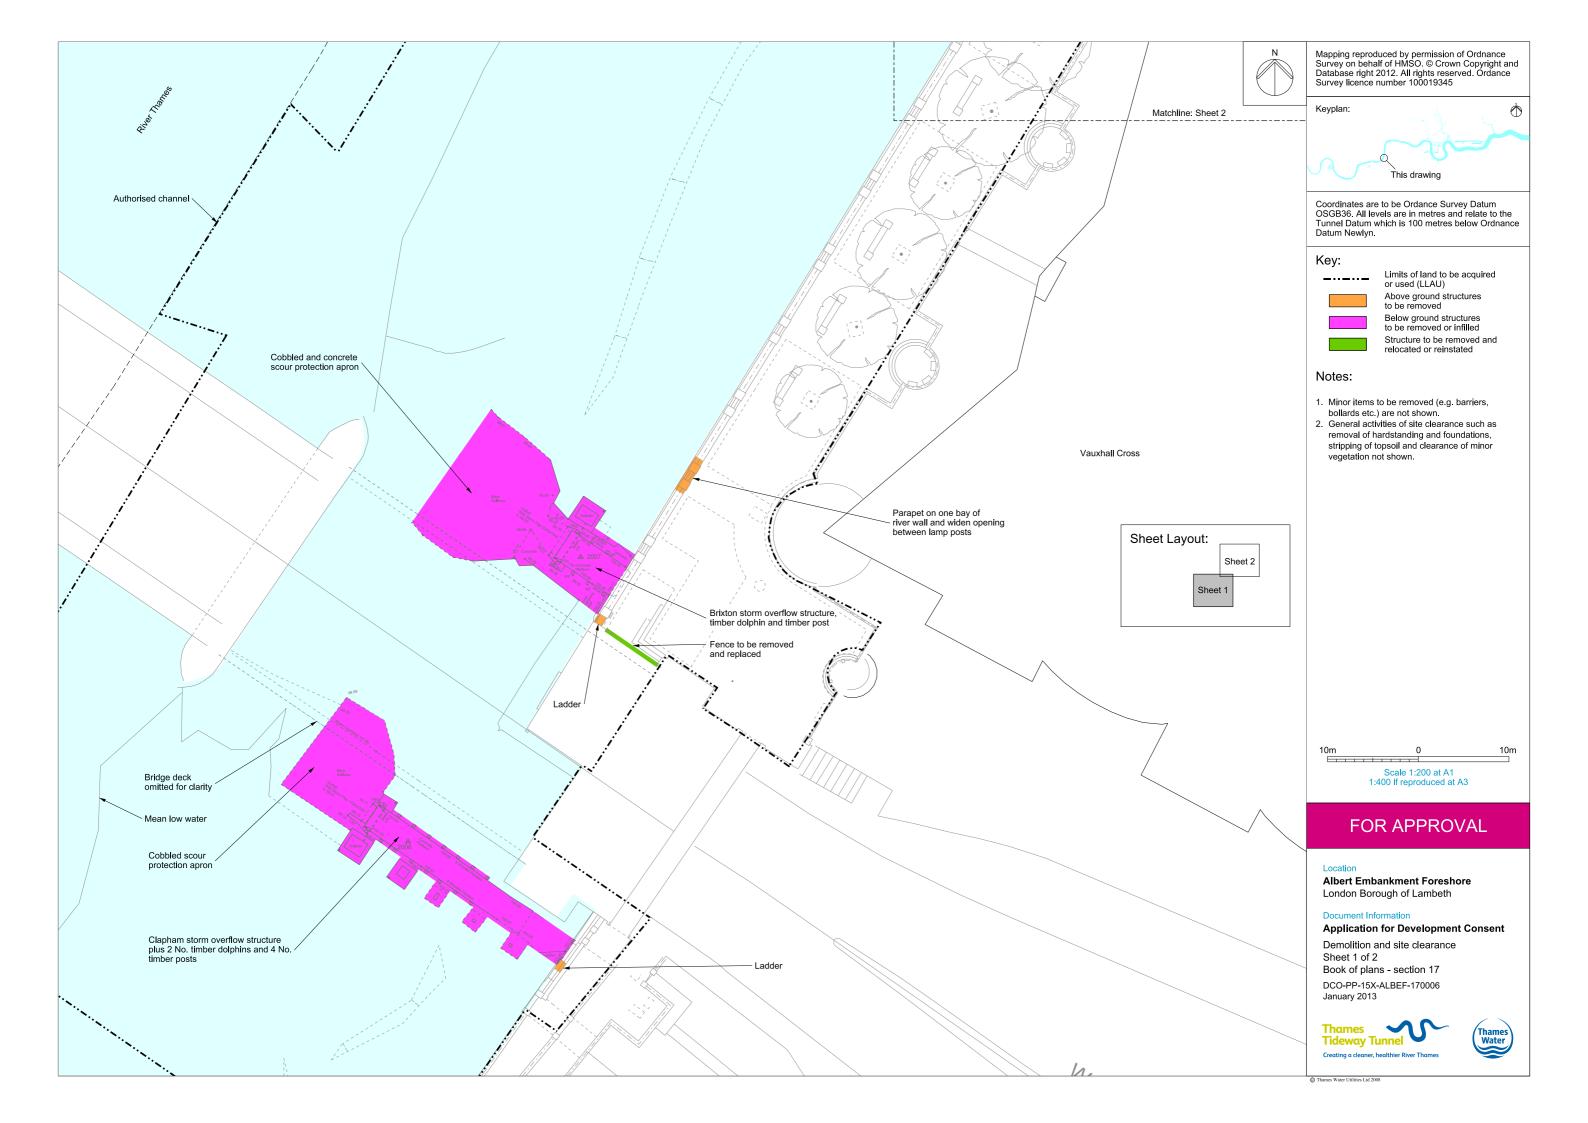


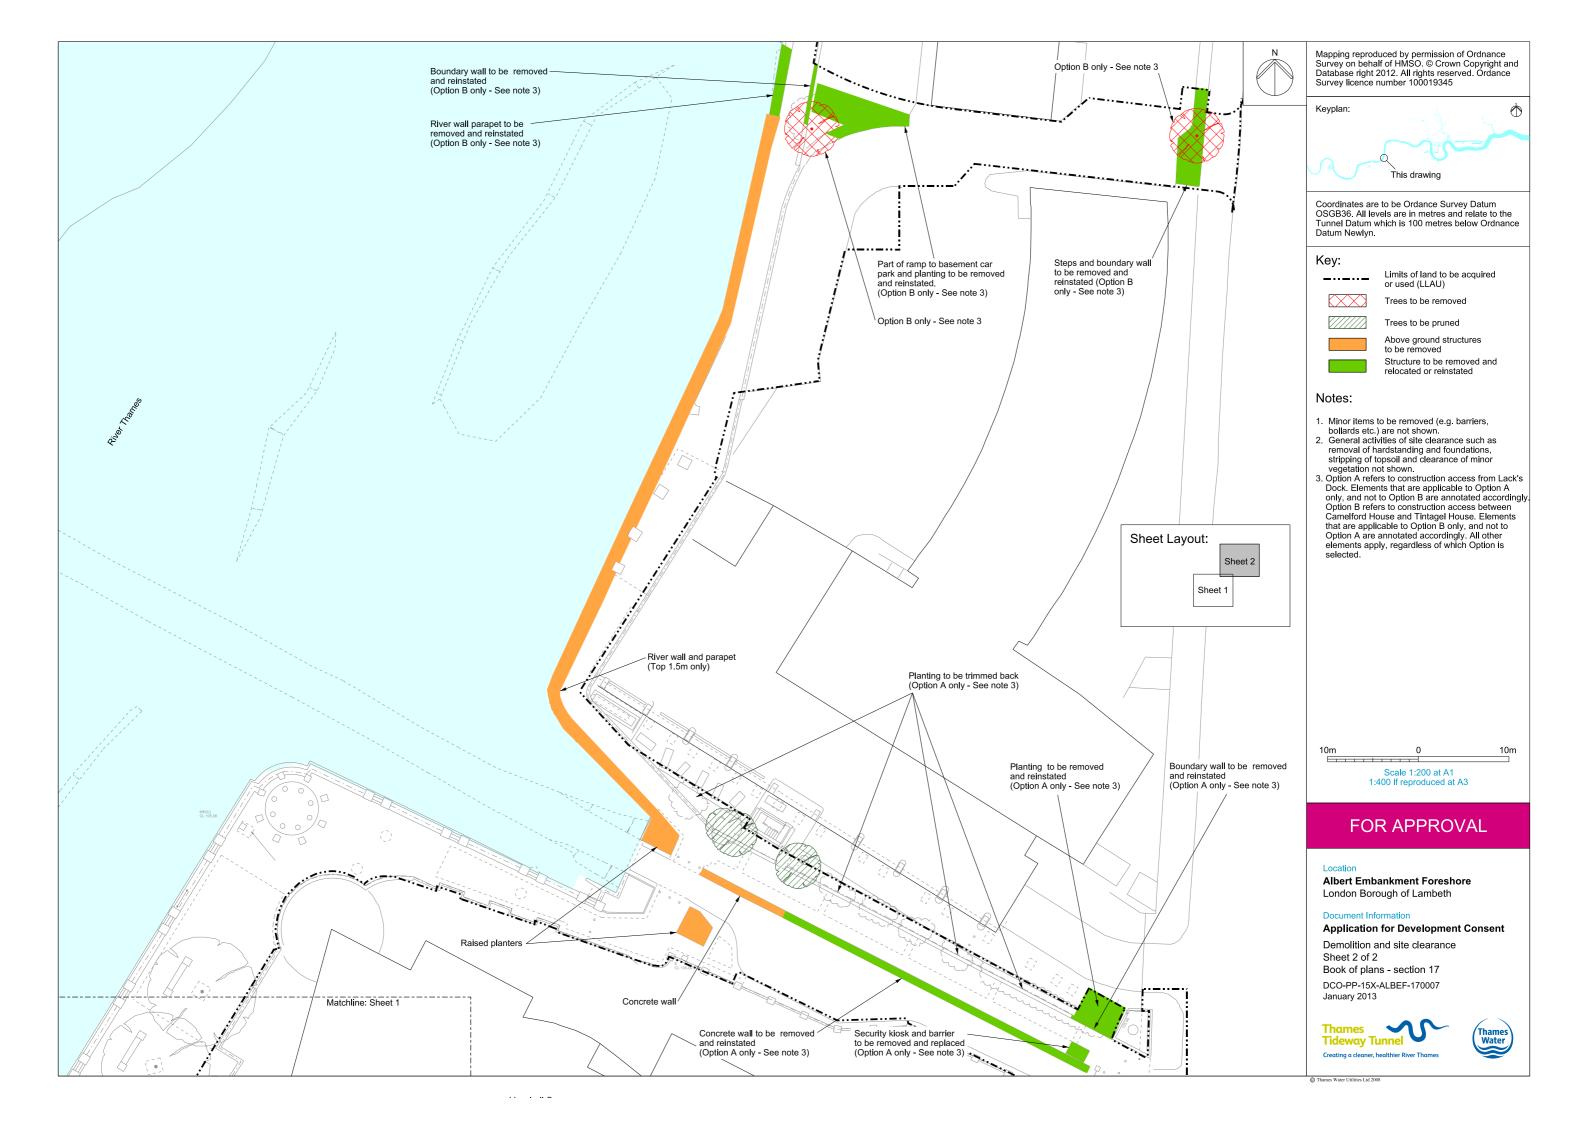


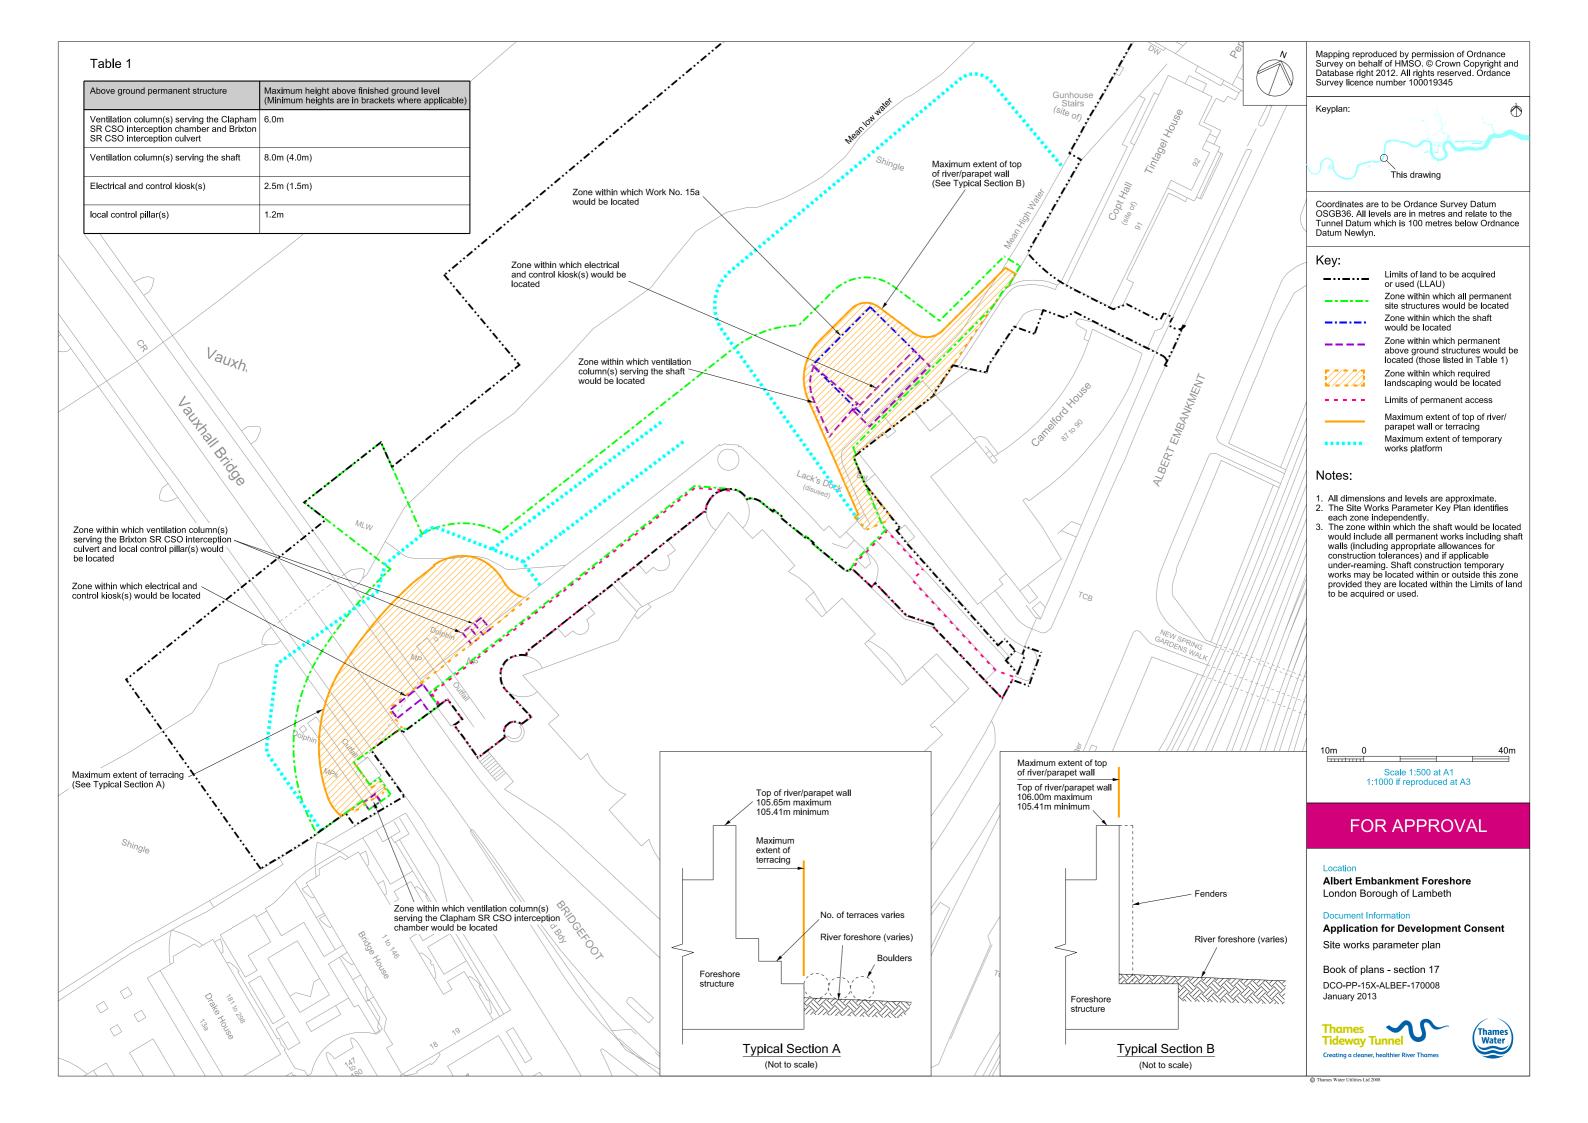





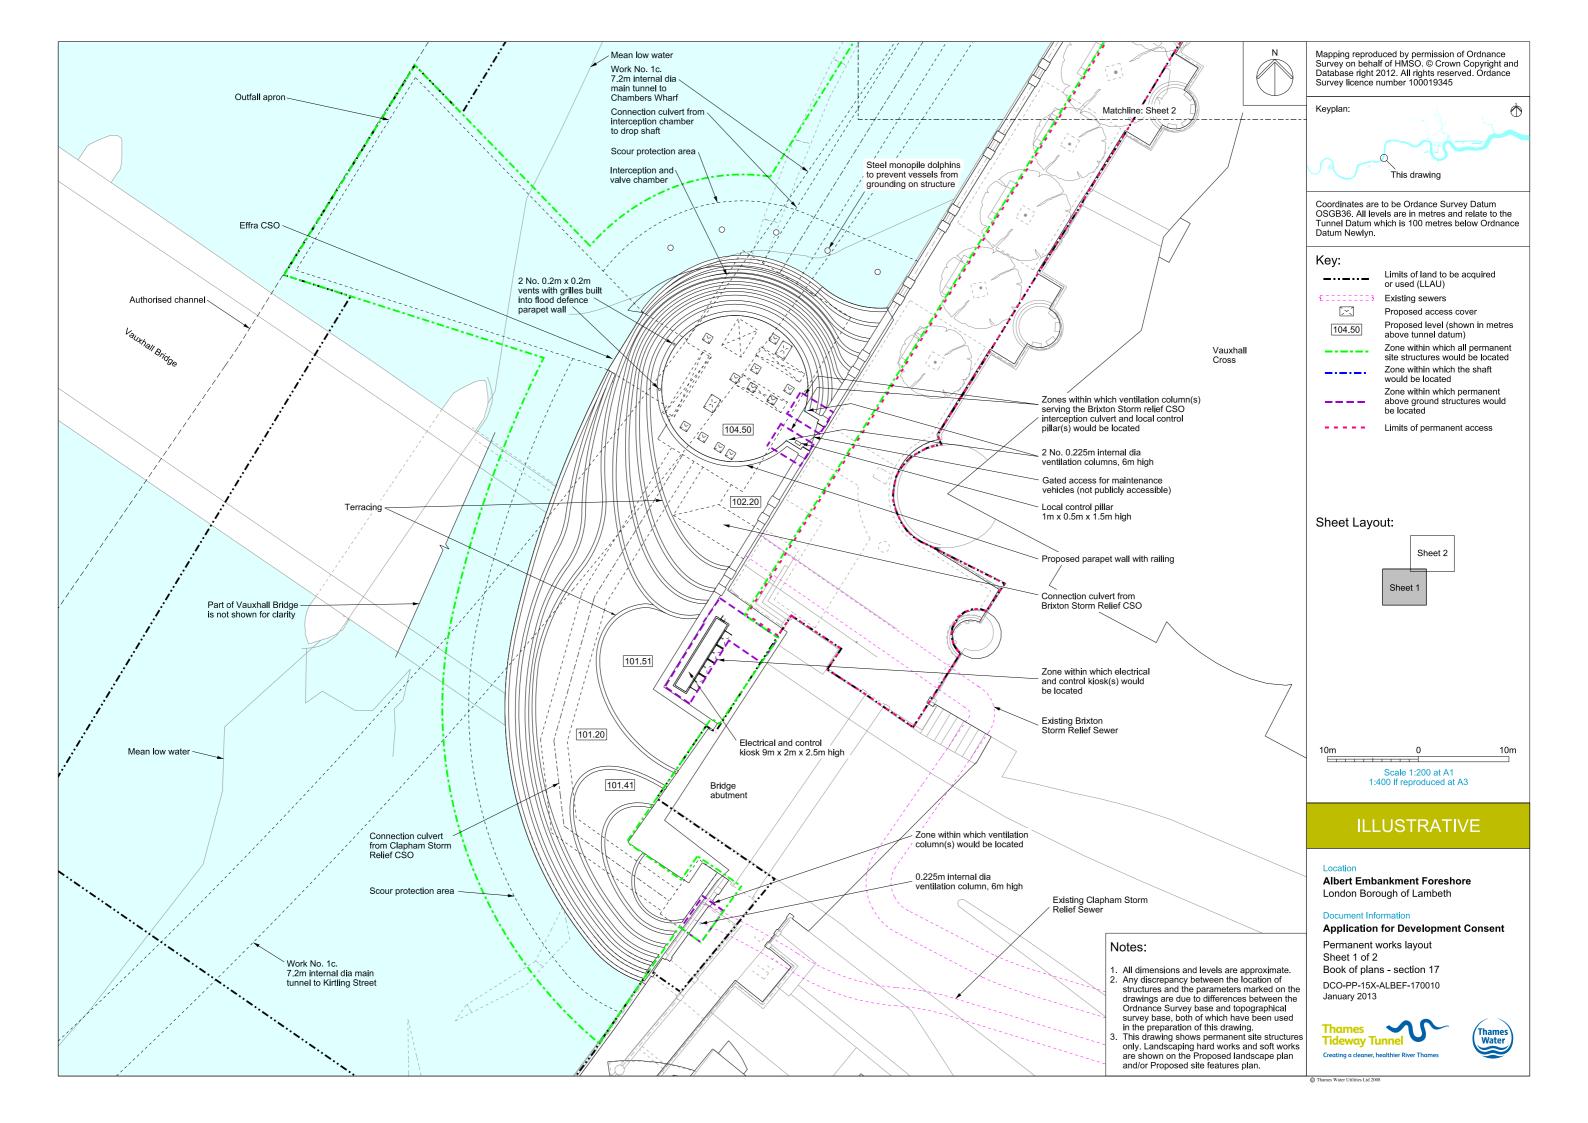


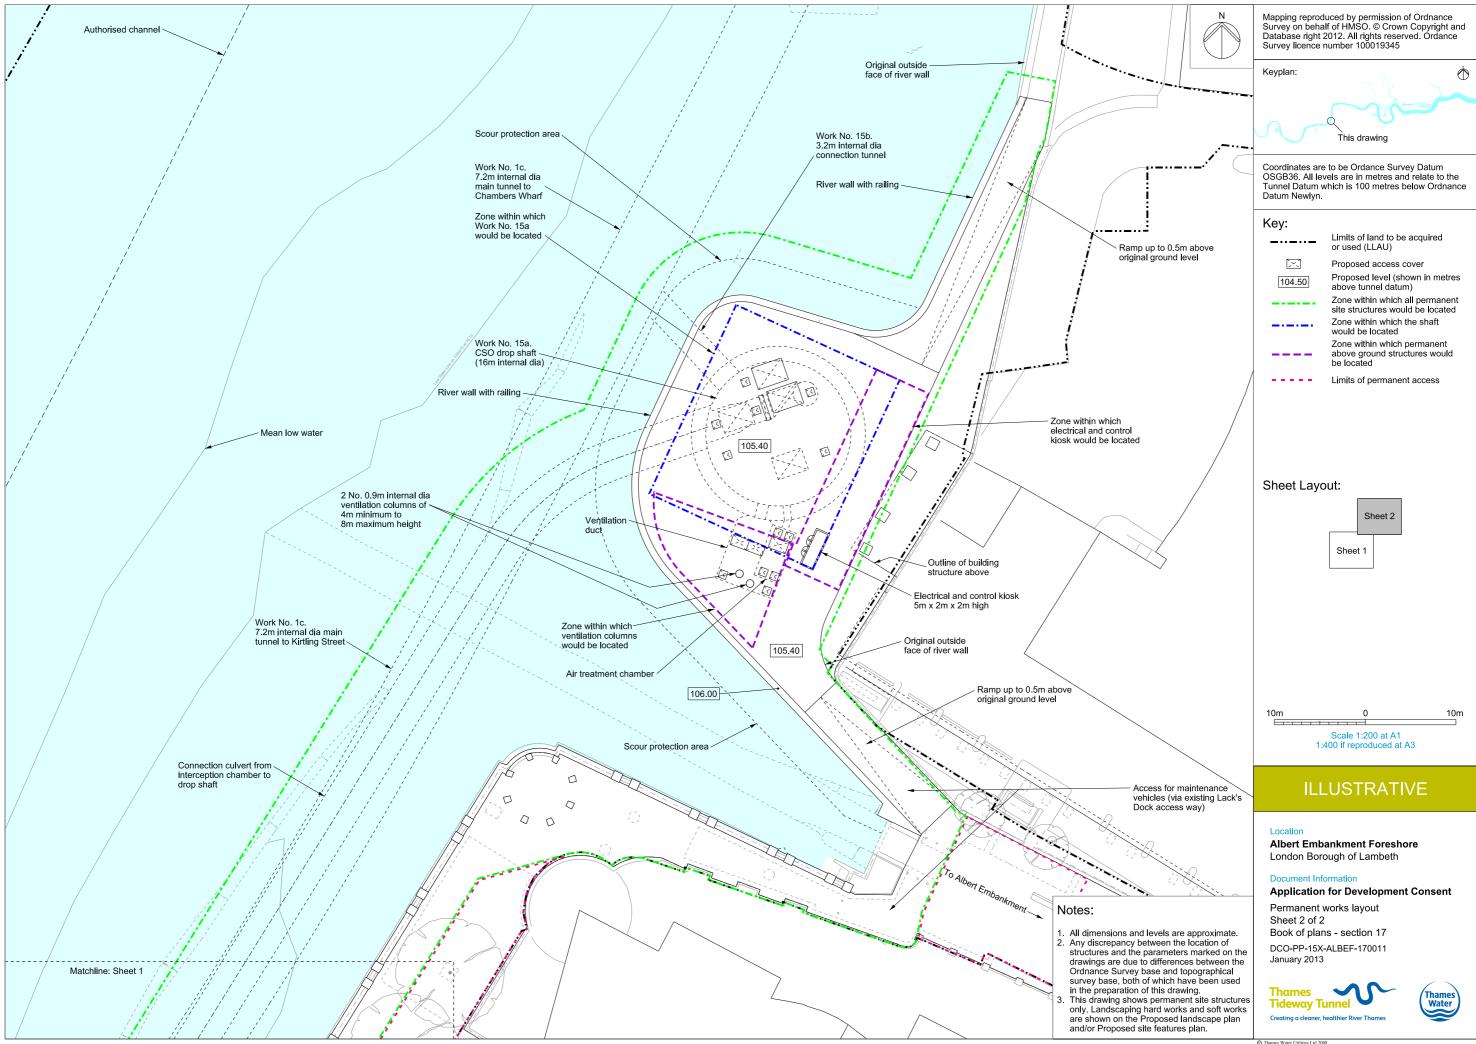


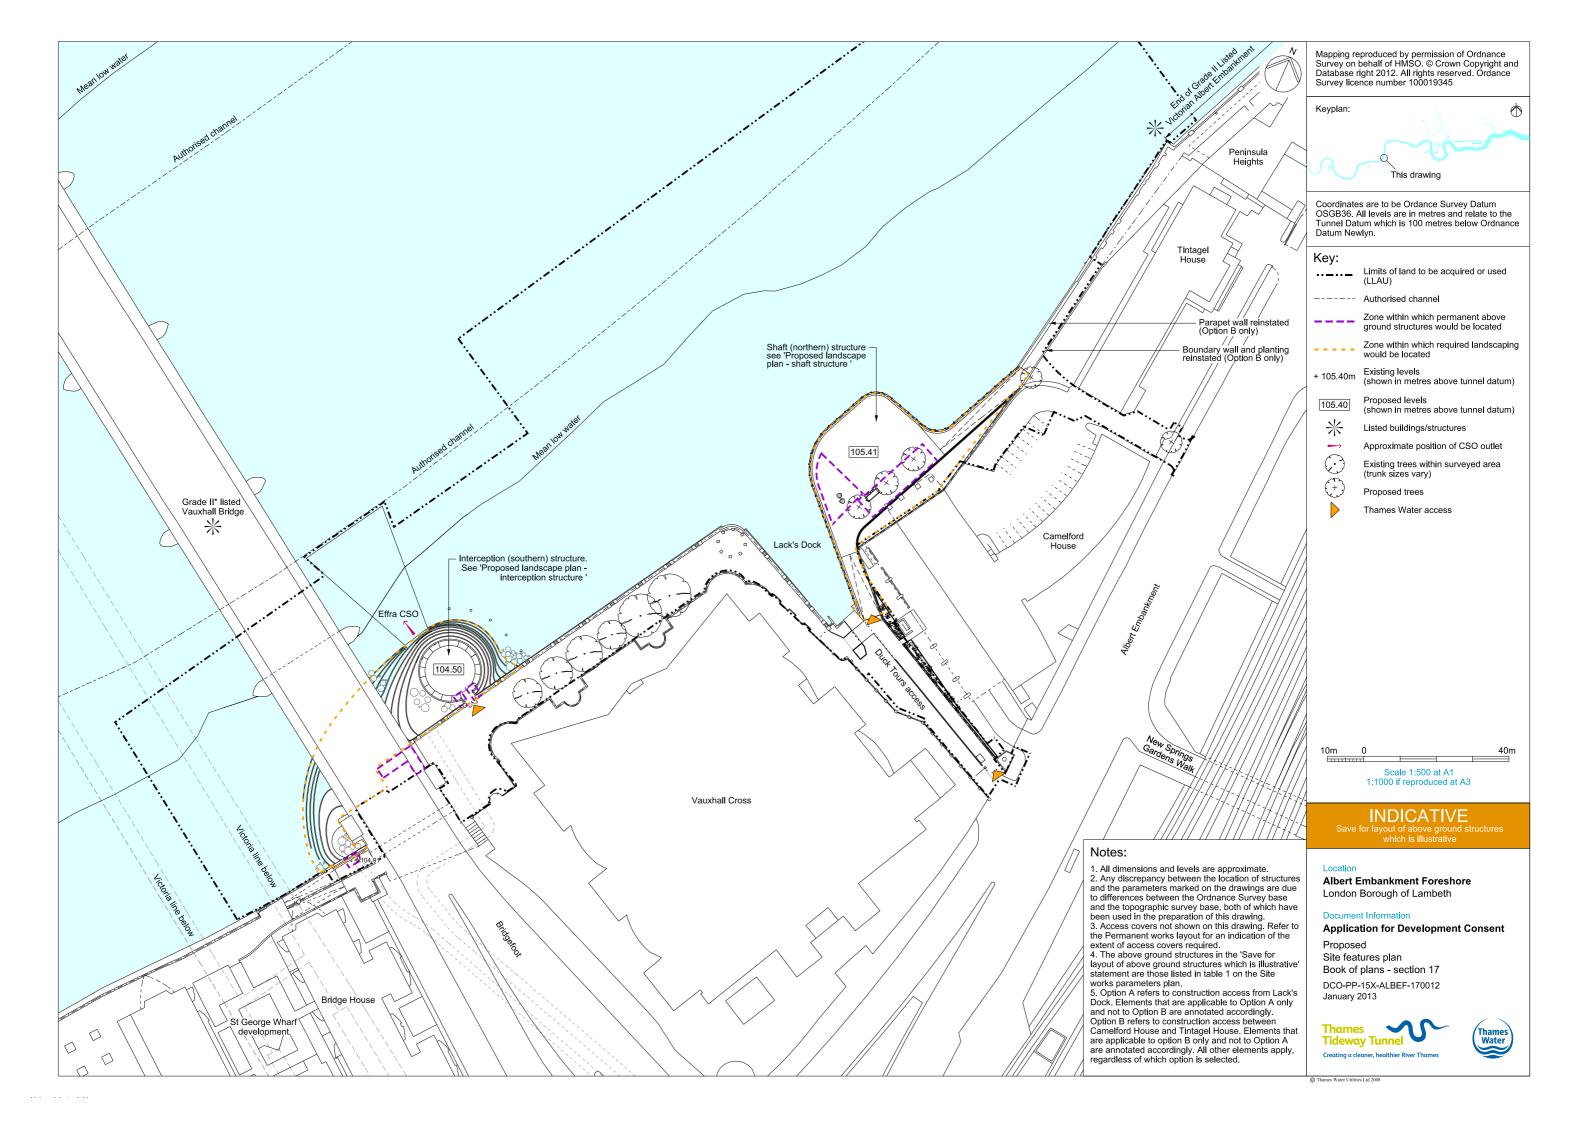


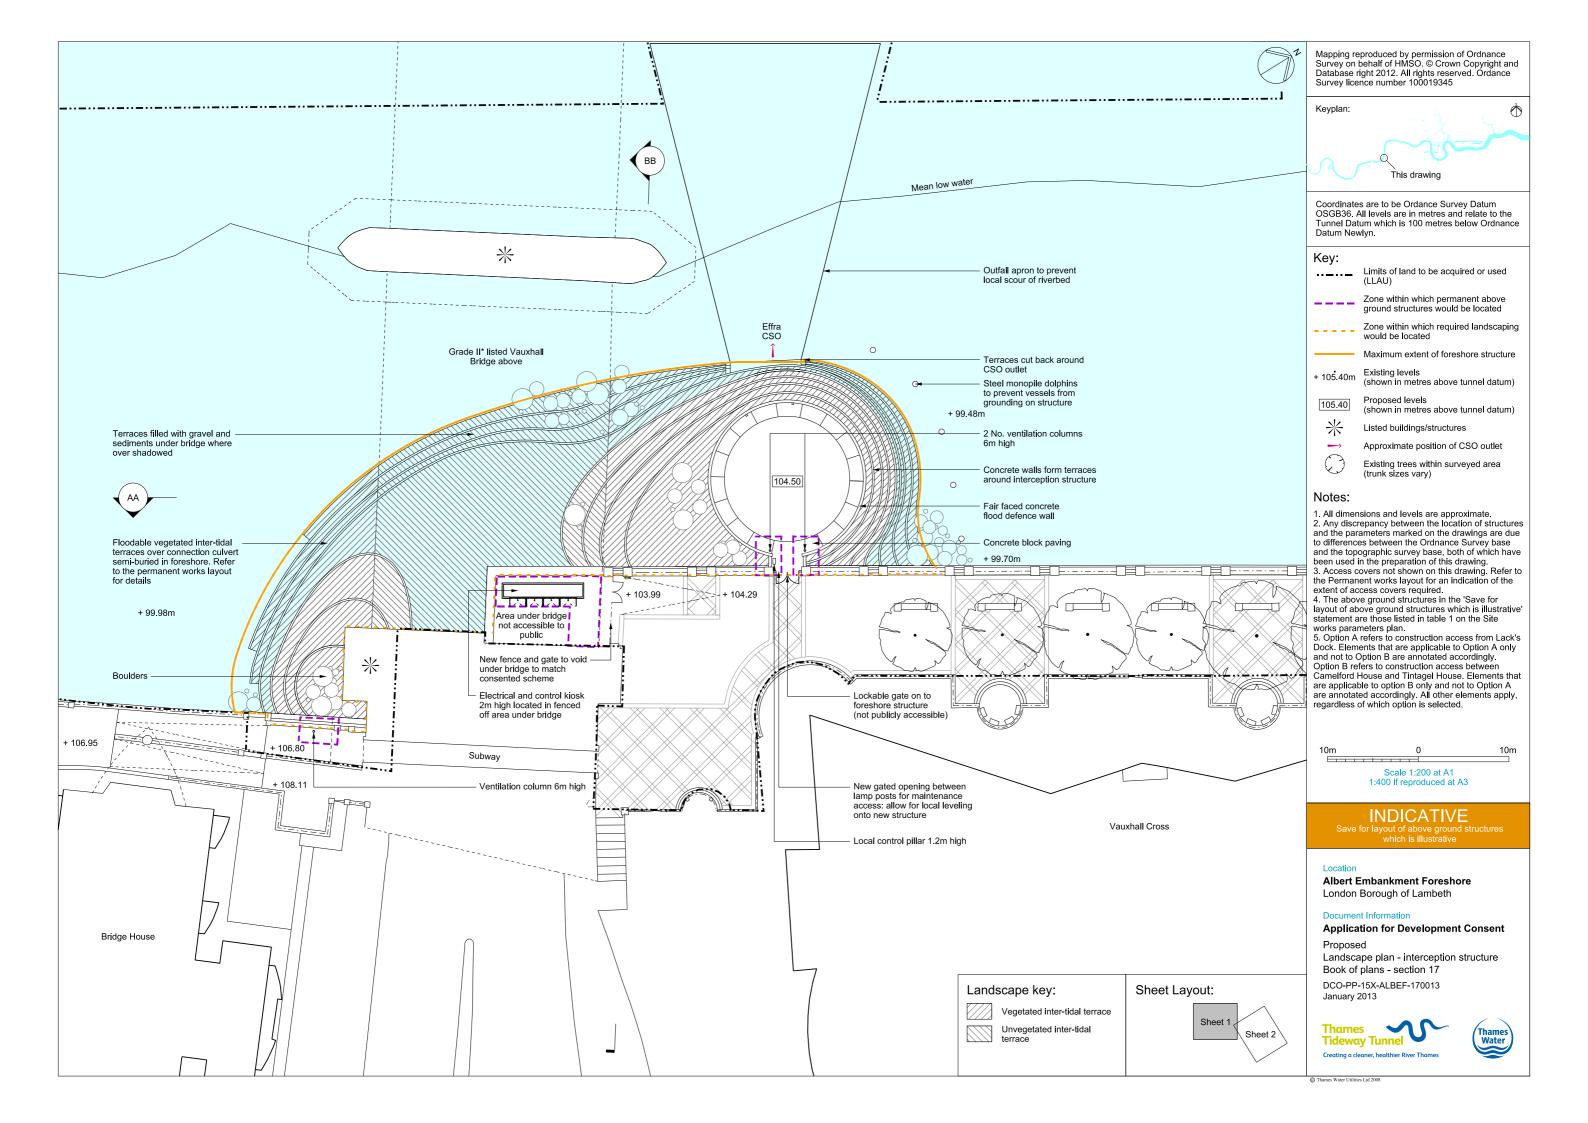

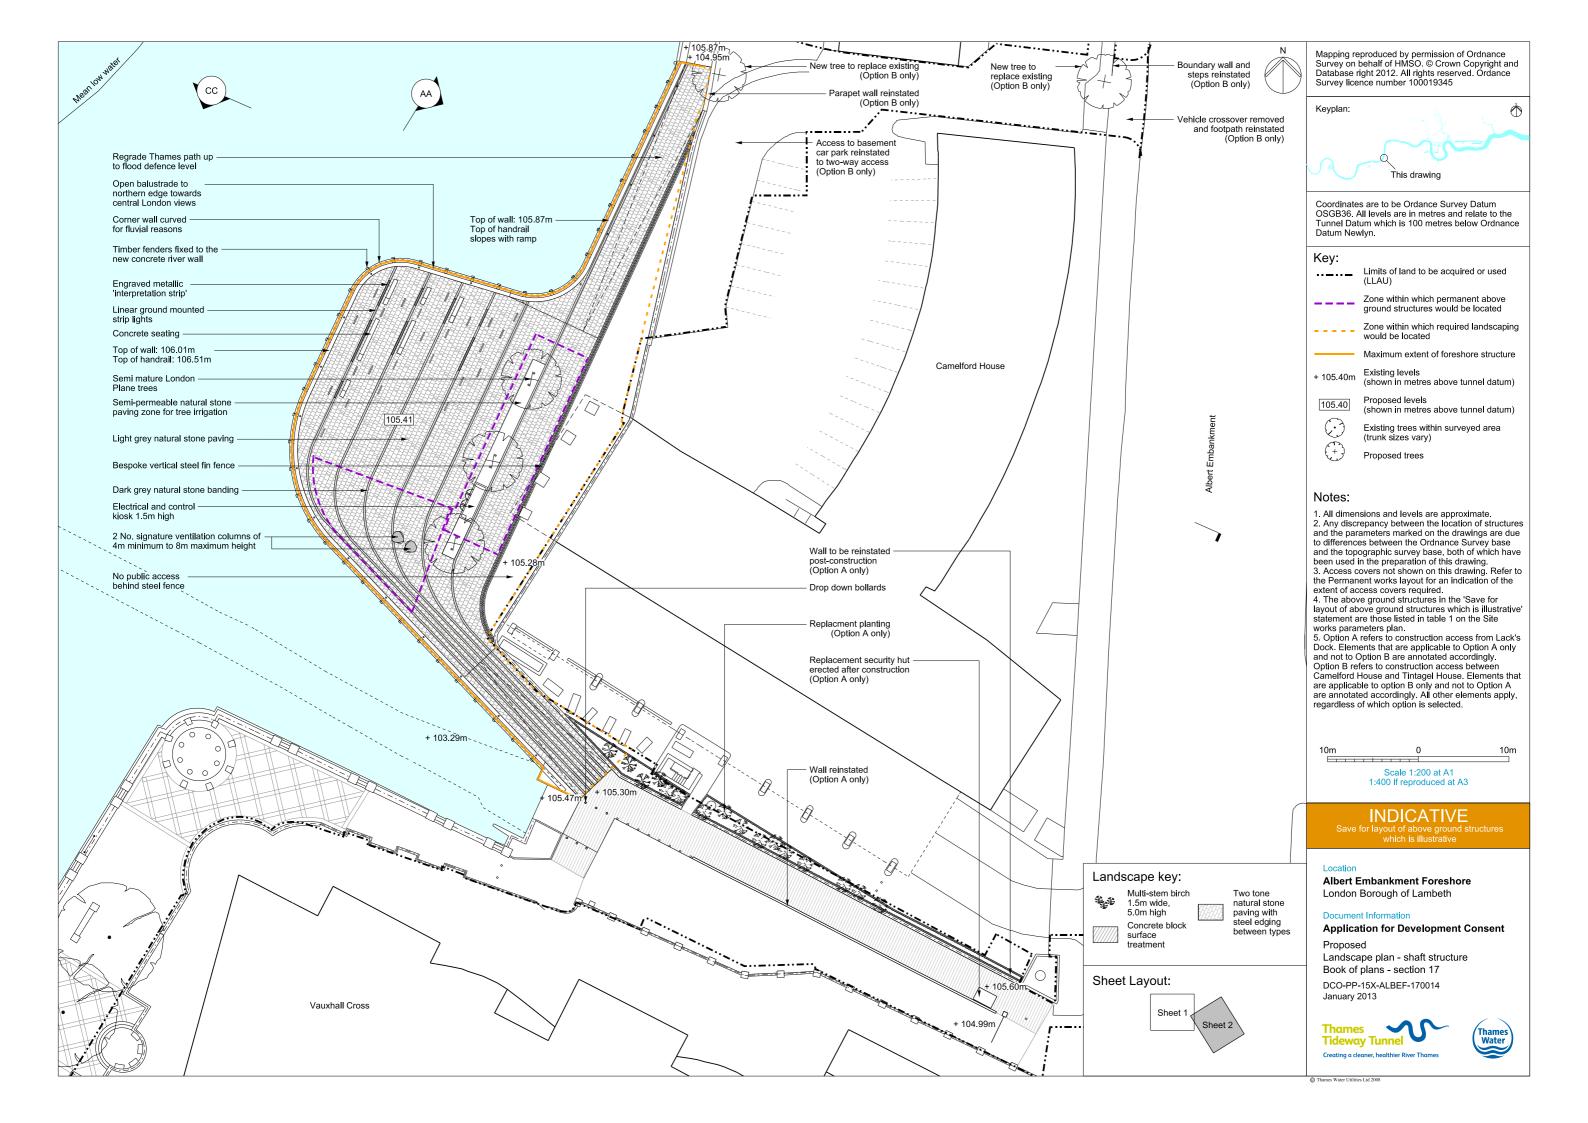

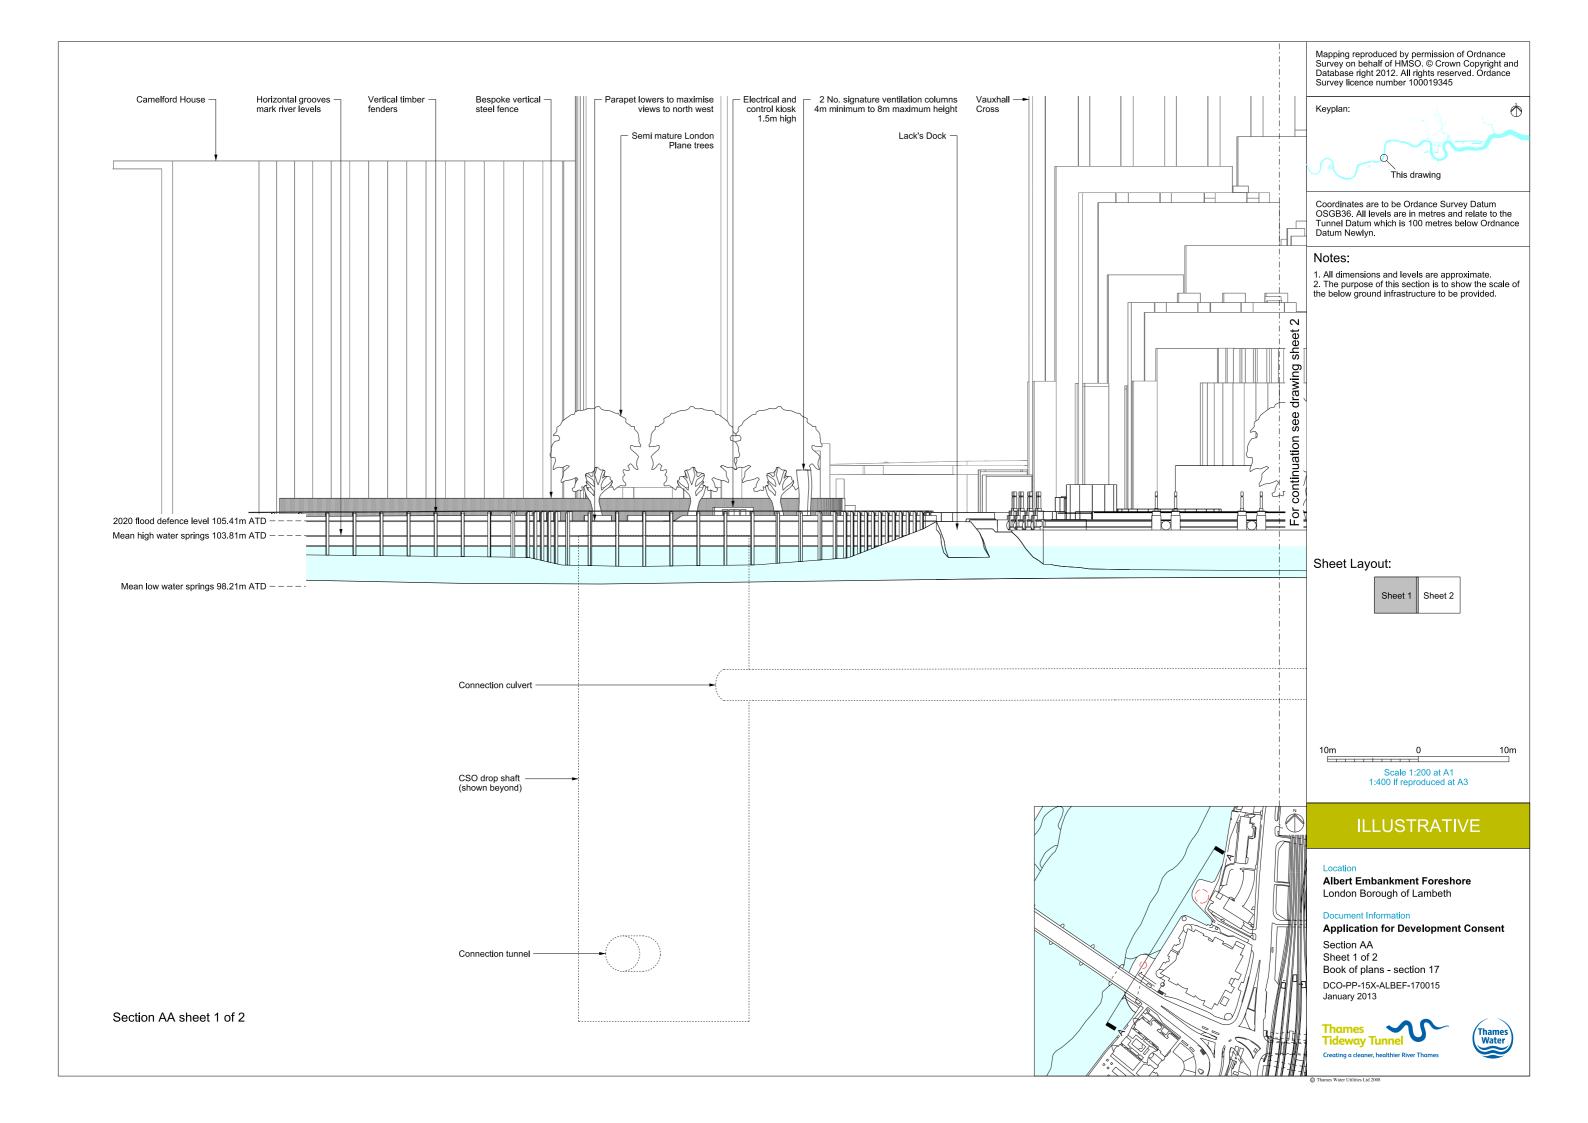

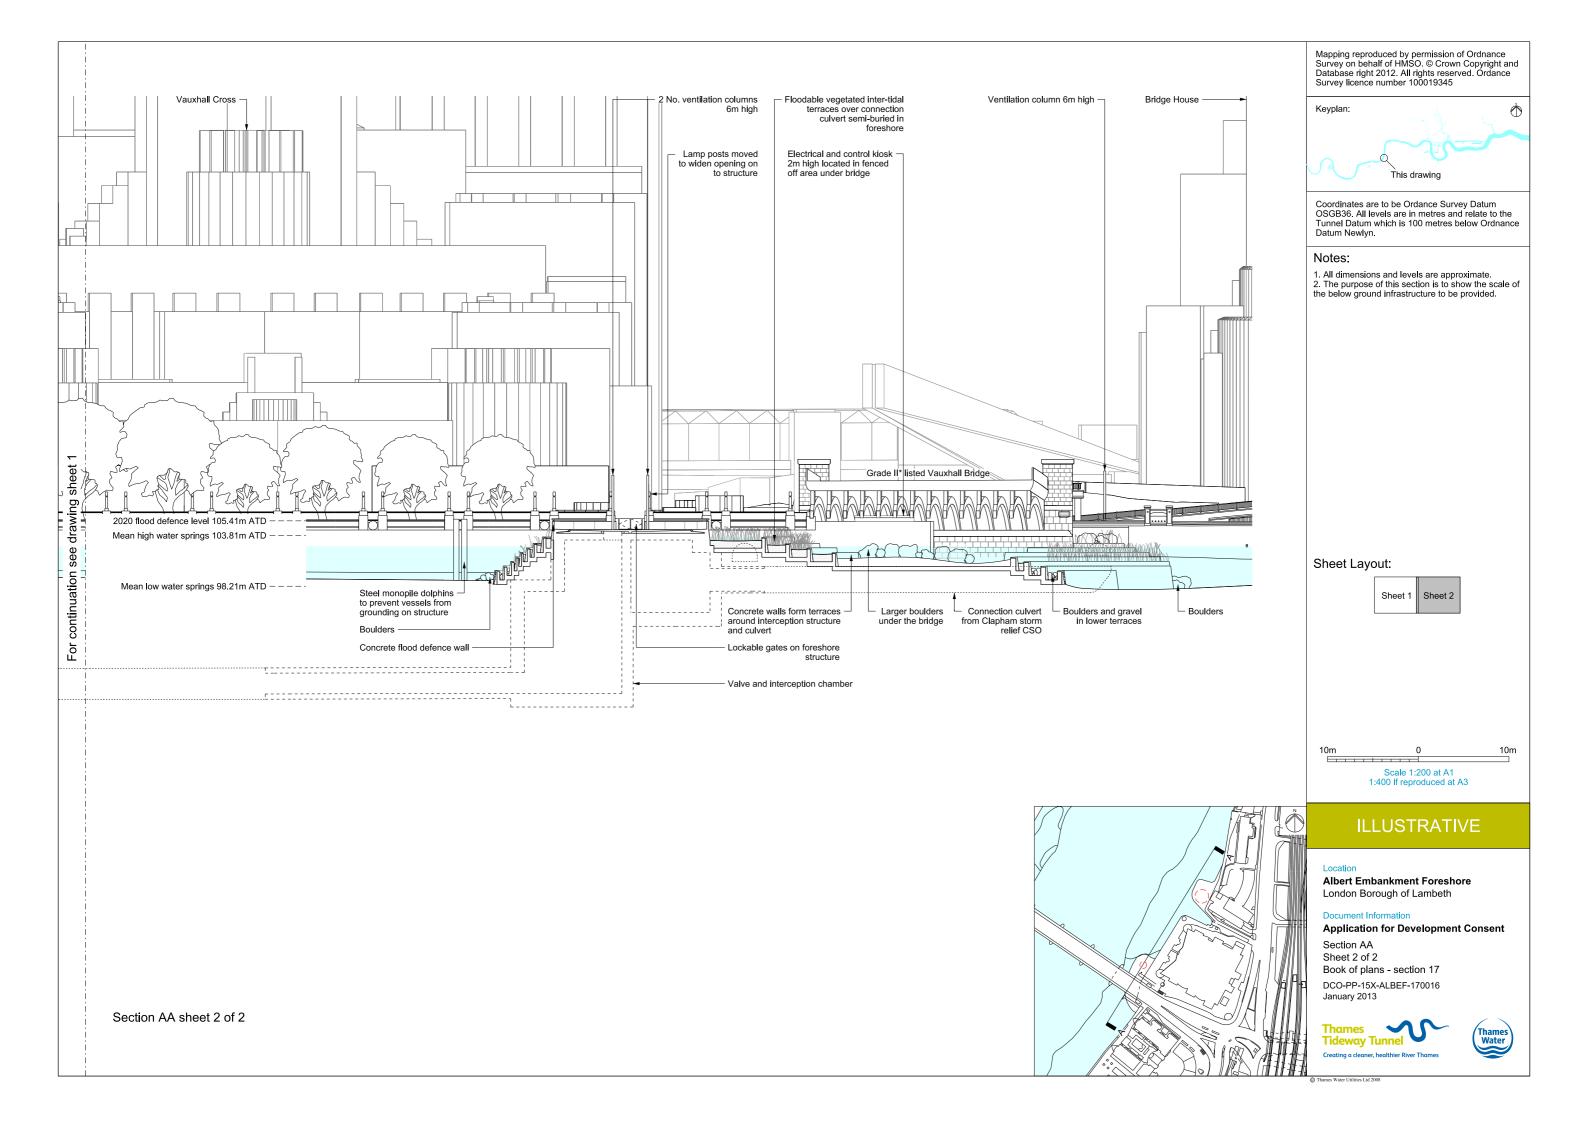

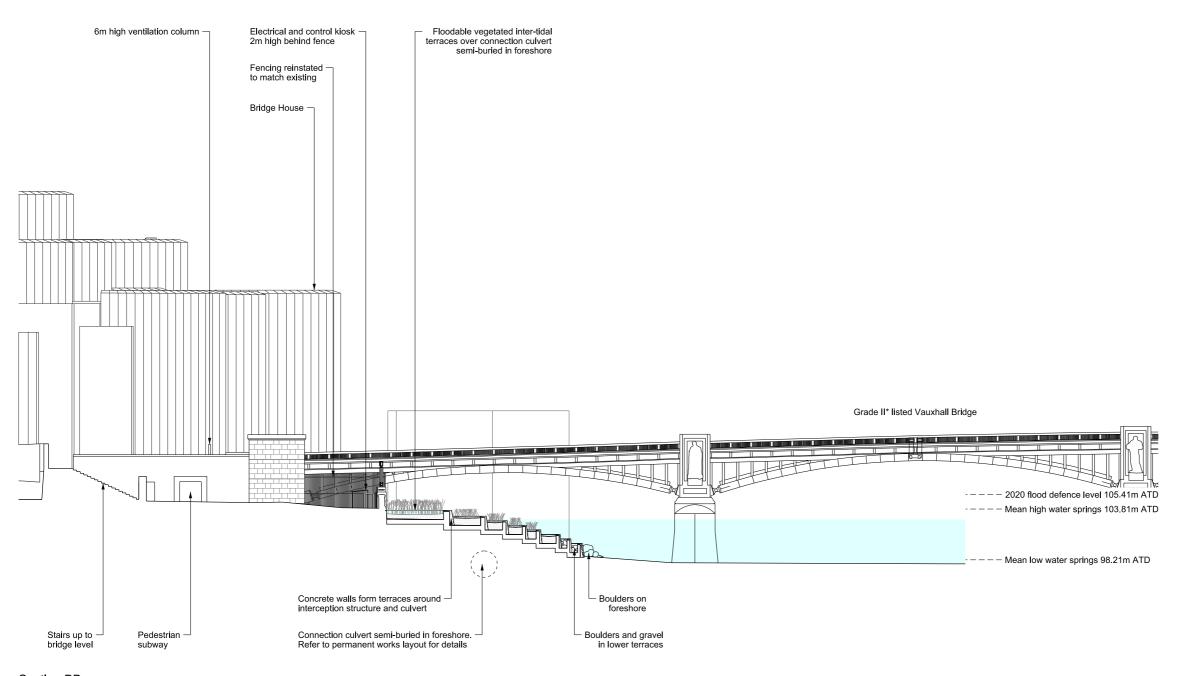

Section BB

Mapping reproduced by permission of Ordnance Survey on behalf of HMSO. © Crown Copyright and Database right 2012. All rights reserved. Ordance Survey licence number 100019345

Keyplan:

This drawing

Coordinates are to be Ordance Survey Datum OSGB36. All levels are in metres and relate to the Tunnel Datum which is 100 metres below Ordnance Datum Newlyn.

Notes:

All dimensions and levels are approximate.
 The purpose of this section is to show the scale of the below ground infrastructure to be provided.

10m 0 10m Scale 1:200 at A1 1:400 if reproduced at A3

ILLUSTRATIVE

Location

Albert Embankment Foreshore London Borough of Lambeth

Document Information

Application for Development Consent


Section BB


Book of plans - section 17 DCO-PP-15X-ALBEF-170017 January 2013

Thames Tideway Tunnel




Thames Water Utilities Ltd 2008

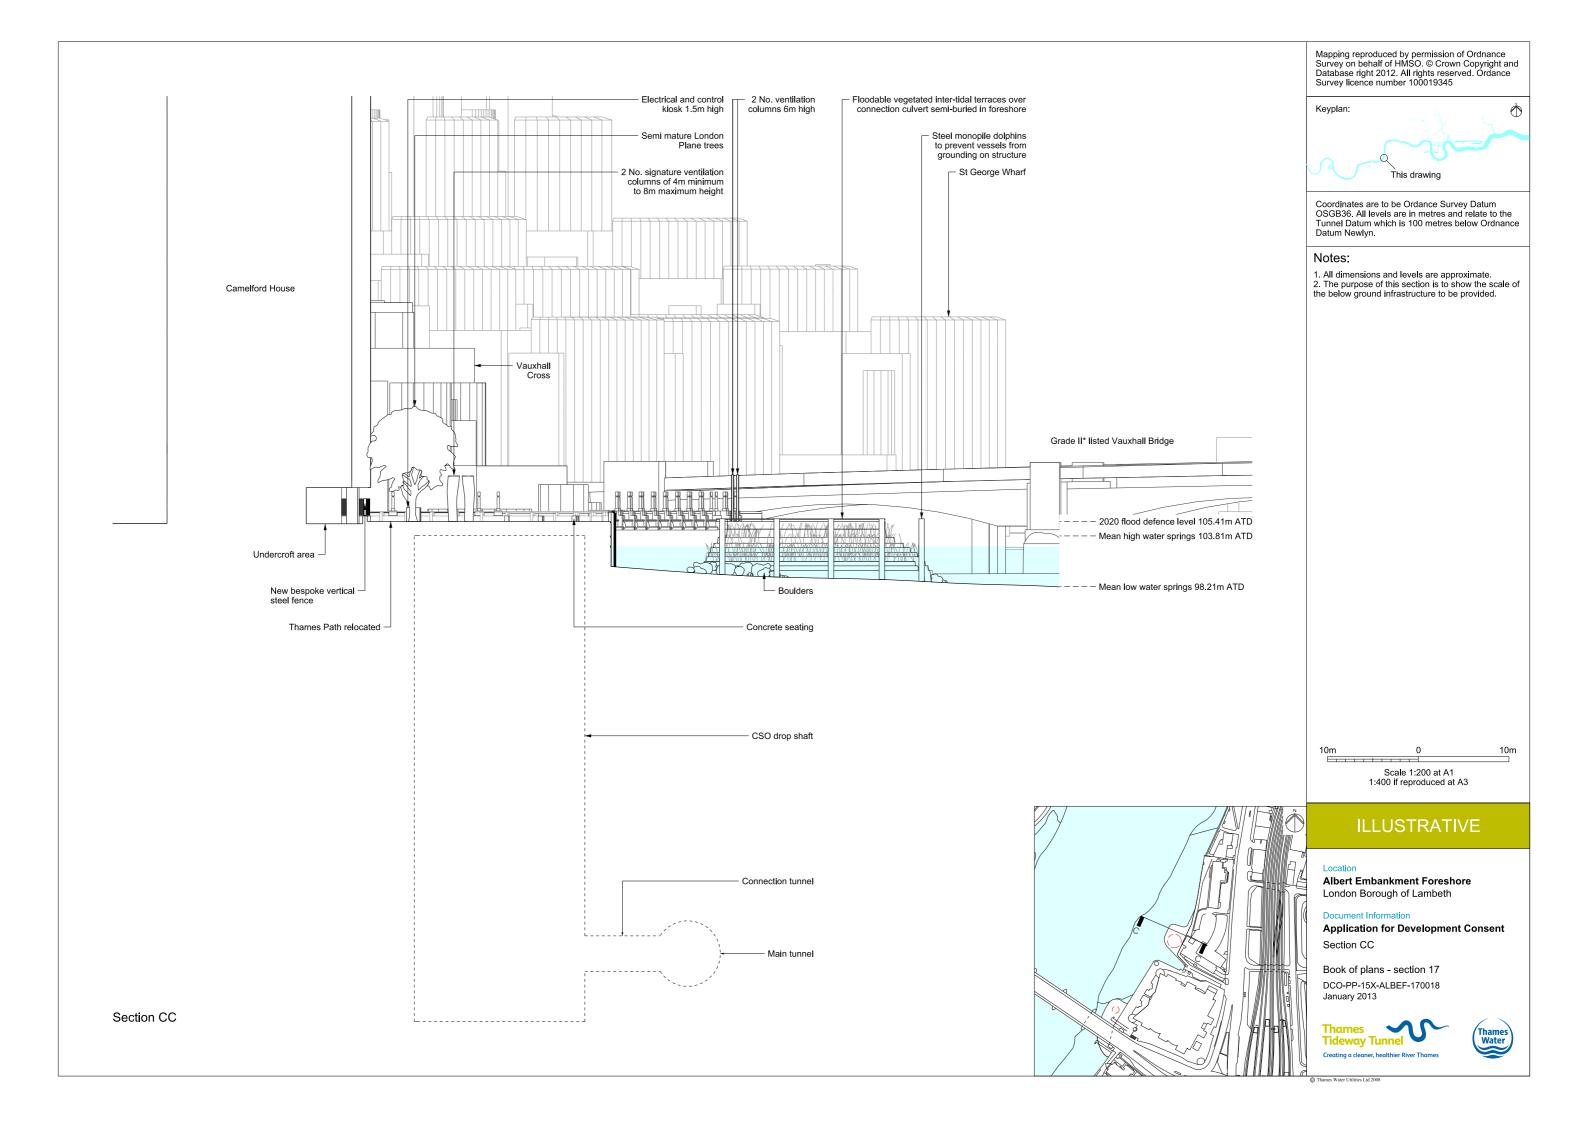


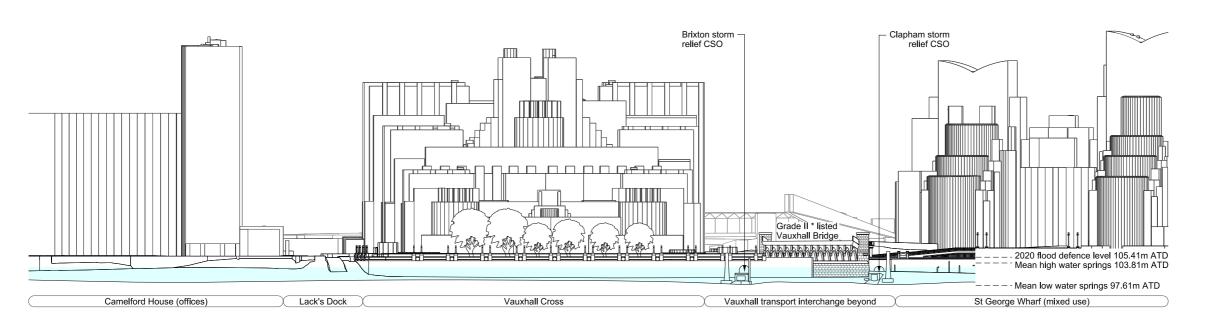

As existing West (river) elevation

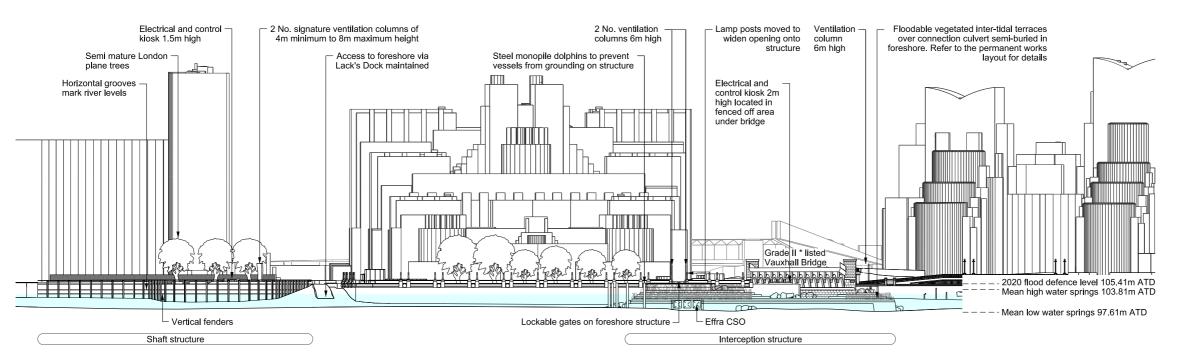


Proposed West (river) elevation

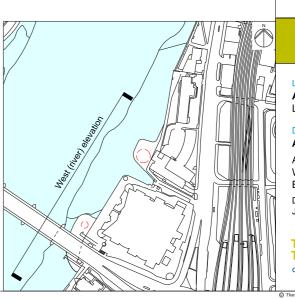

Mapping reproduced by permission of Ordnance Survey on behalf of HMSO. © Crown Copyright and Database right 2012. All rights reserved. Ordance Survey licence number 100019345

Keyplan:

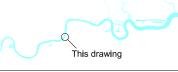

Coordinates are to be Ordance Survey Datum OSGB36, All levels are in metres and relate to the Tunnel Datum which is 100 metres below Ordnance Datum Newlyn.

Notes:

1. All dimensions and levels are approximate.

10m 0 40n

Scale 1:500 at A1
1:1000 if reproduced at A3

ILLUSTRATIVE

Location

Albert Embankment Foreshore London Borough of Lambeth

Document Information


Application for Development Consent

As existing and proposed West (river) elevation Book of plans - section 17 DCO-PP-15X-ALBEF-170019 January 2013






↑ Thames Water Utilities Ltd 2008

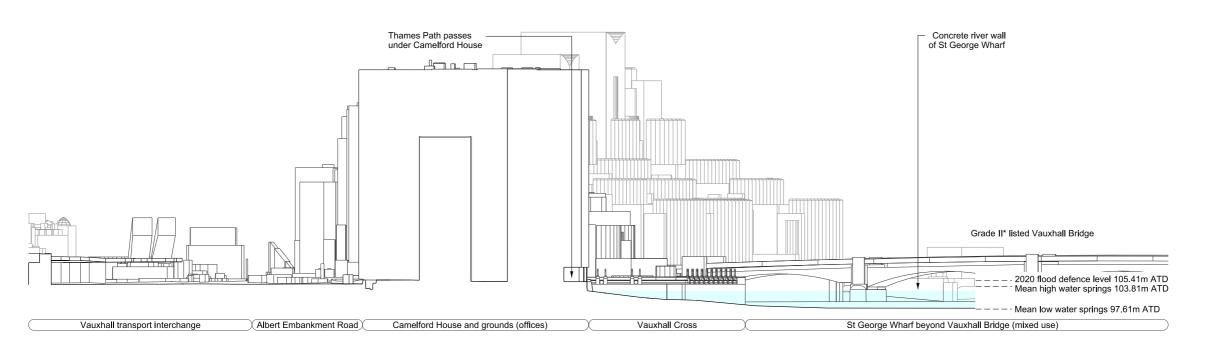

As existing North elevation

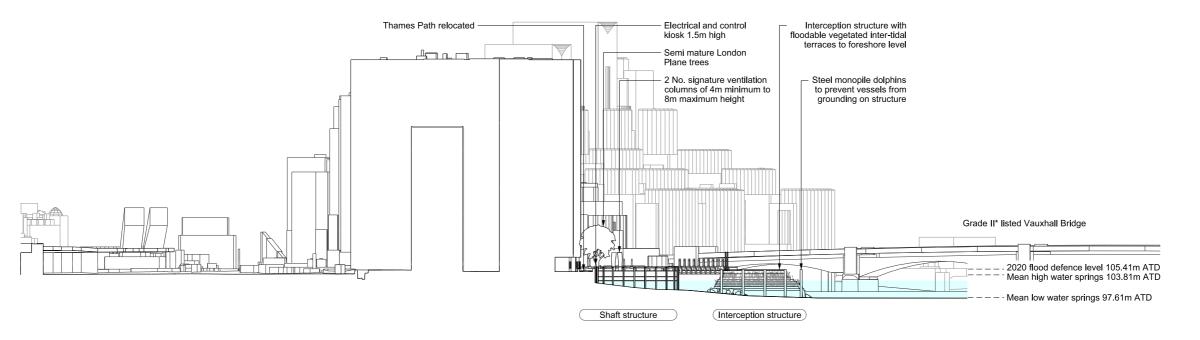

Proposed North elevation

Mapping reproduced by permission of Ordnance Survey on behalf of HMSO. © Crown Copyright and Database right 2012. All rights reserved. Ordance Survey licence number 100019345

Keyplan:

This drawing

Coordinates are to be Ordance Survey Datum OSGB36. All levels are in metres and relate to the Tunnel Datum which is 100 metres below Ordnance Datum Newlyn.

Notes:

1. All dimensions and levels are approximate.

10m 0 40m

Scale 1:500 at A1
1:1000 if reproduced at A3

ILLUSTRATIVE

Location

Albert Embankment Foreshore London Borough of Lambeth

Document Information


Application for Development Consent


As existing and proposed North elevation Book of plans - section 17 DCO-PP-15X-ALBEF-170020 January 2013






Thames Water Utilities Ltd 2008

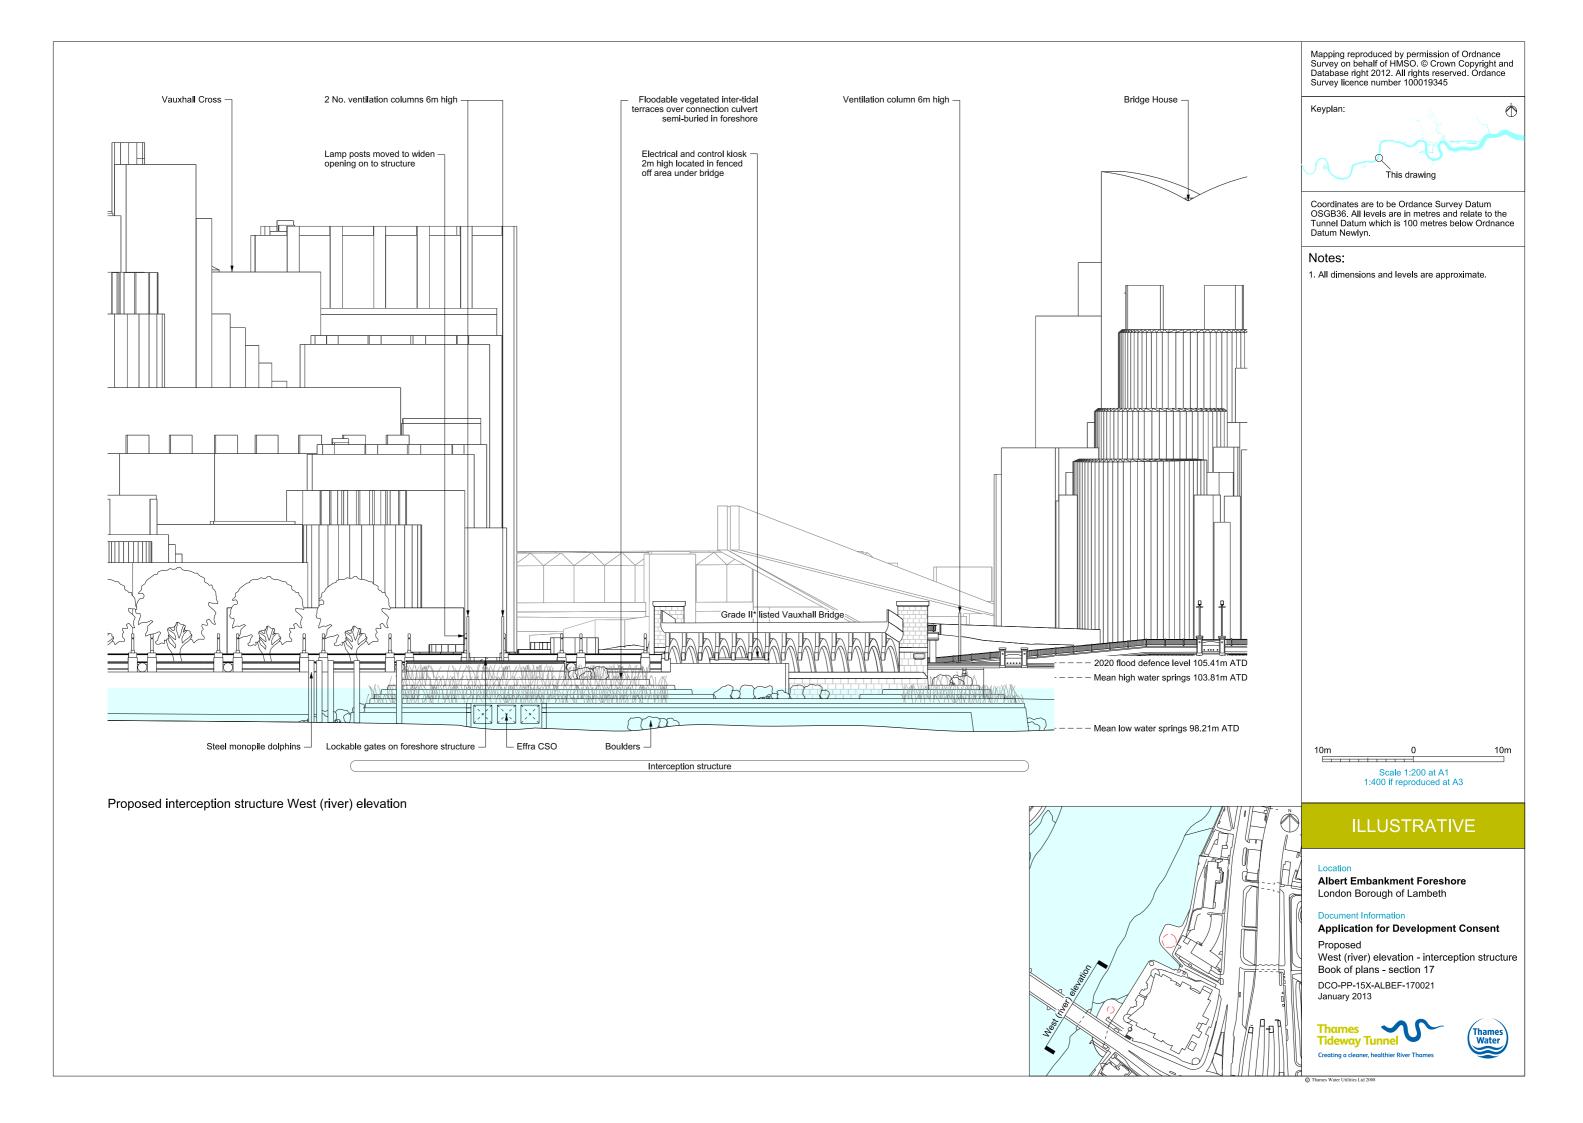

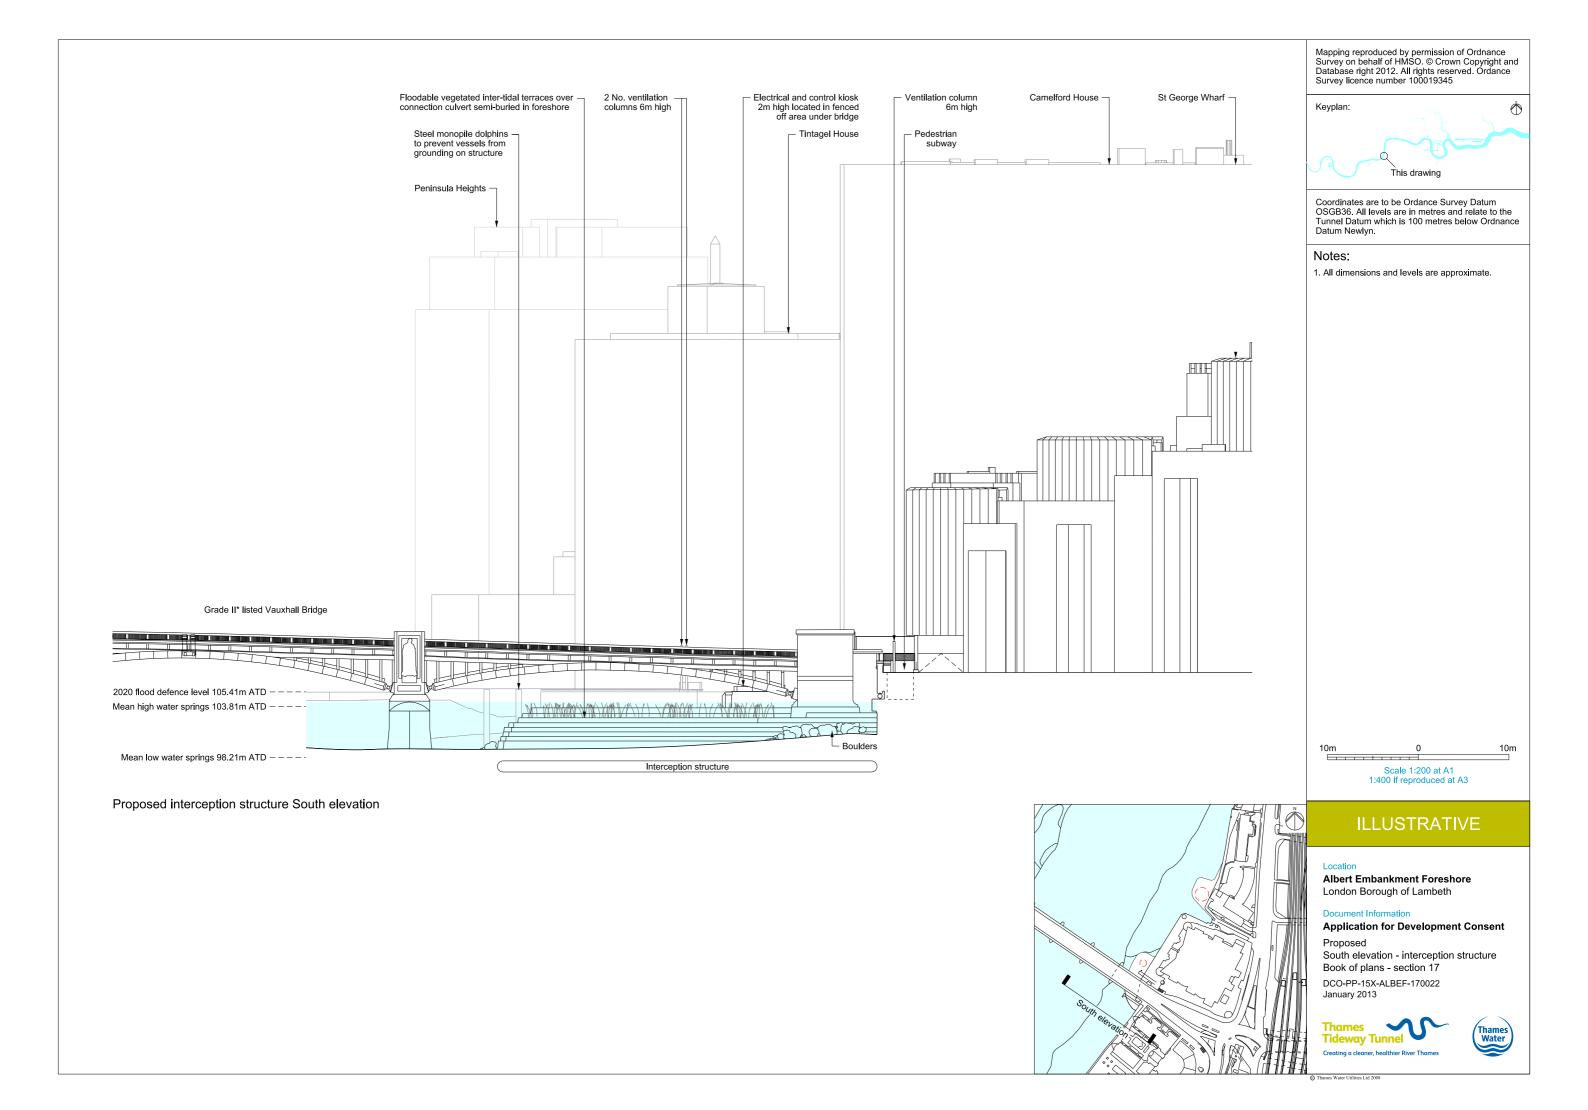

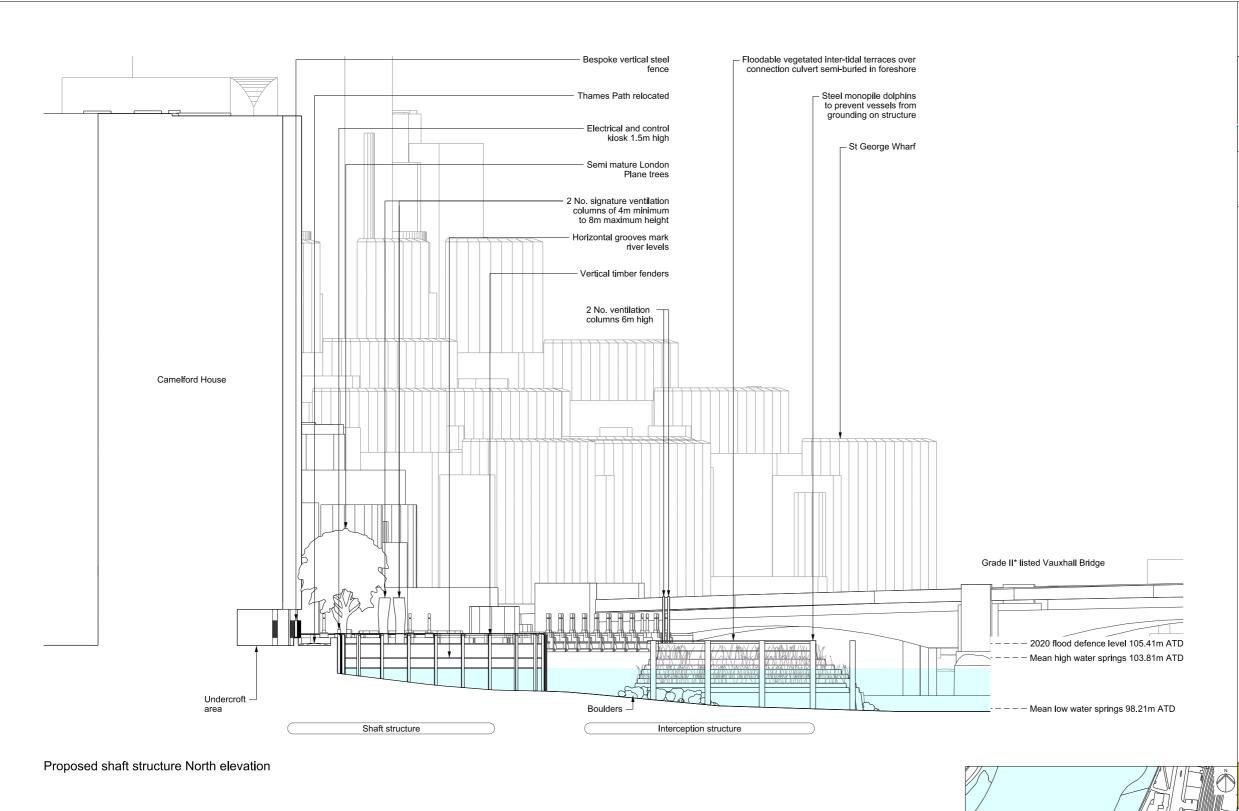

Keyplan:

Coordinates are to be Ordance Survey Datum OSGB36. All levels are in metres and relate to the Tunnel Datum which is 100 metres below Ordnance Datum Newlyn.

Notes:

1. All dimensions and levels are approximate.

10m Scale 1:200 at A1 1:400 if reproduced at A3

ILLUSTRATIVE

Albert Embankment Foreshore London Borough of Lambeth

Application for Development Consent


Proposed

North elevation - shaft structure Book of plans - section 17 DCO-PP-15X-ALBEF-170023

January 2013





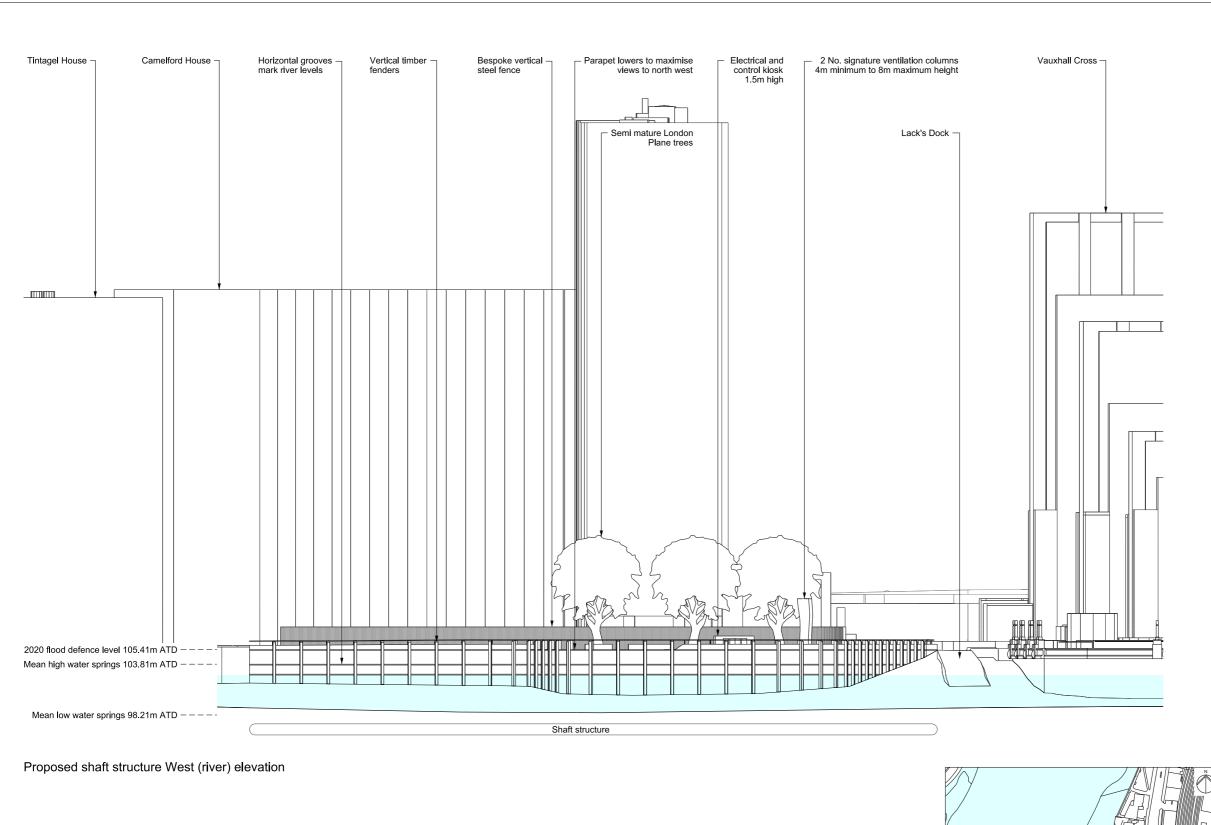

Keyplan:

This drawing

Coordinates are to be Ordance Survey Datum OSGB36. All levels are in metres and relate to the Tunnel Datum which is 100 metres below Ordnance Datum Newlyn.

Notes:

All dimensions and levels are approximate.

10m 0 10m Scale 1:200 at A1 1:400 if reproduced at A3

ILLUSTRATIVE

Location

Albert Embankment Foreshore London Borough of Lambeth

Document Information

Application for Development Consent

Proposed


West (river) elevation - shaft structure Book of plans - section 17


DCO-PP-15X-ALBEF-170024 January 2013






↑ Thames Water Utilities Ltd 2008

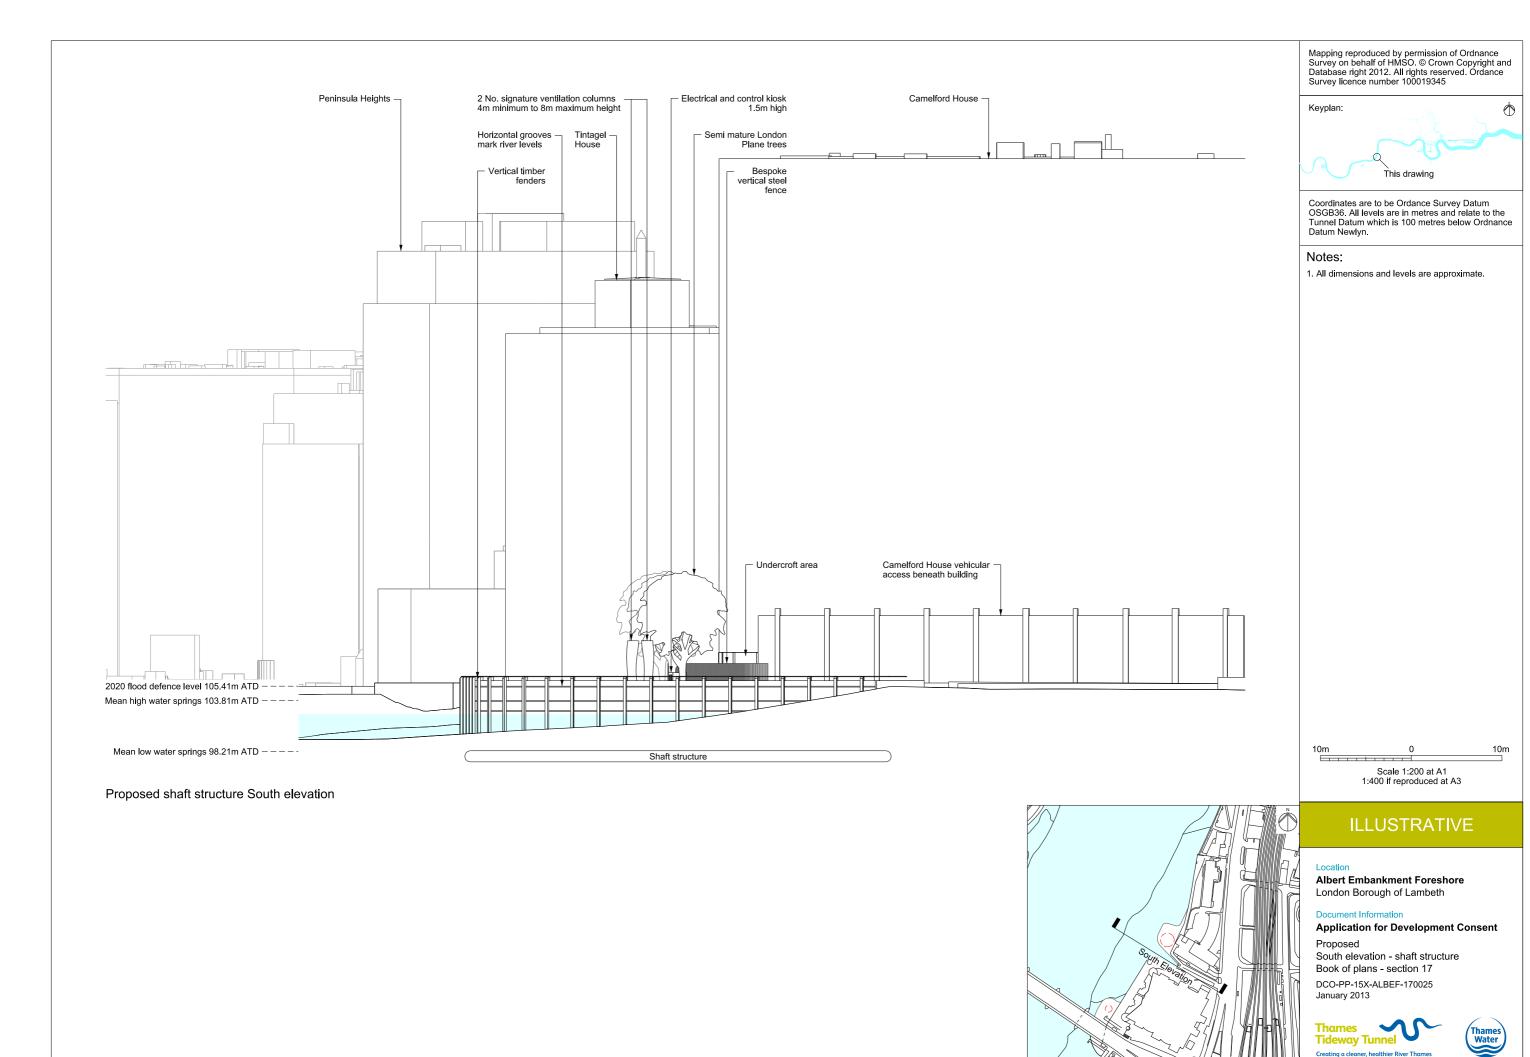

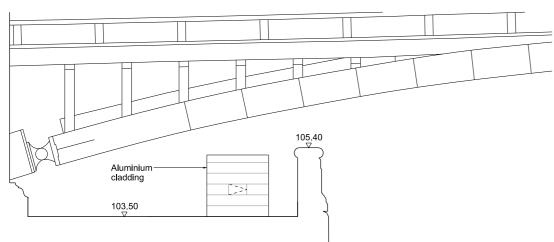

Interception structure kiosk North elevation

Scale 1:50

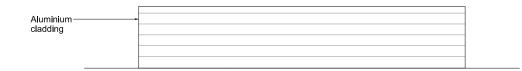

Interception structure kiosk West elevation

Scale 1:50




Interception structure kiosk East elevation

Scale 1:50




Interception structure kiosk roof plan

Scale 1:50

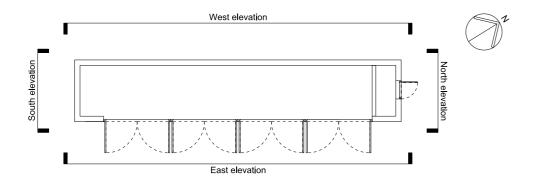


Interception structure kiosk plan

Scale 1:50

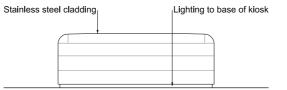


Shaft structure kiosk East elevation

Scale 1:50

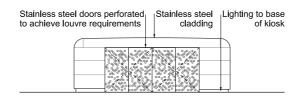


Shaft structure kiosk West elevation

Scale 1:50

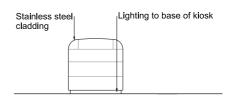

Shaft structure kiosk South elevation

Scale 1:50

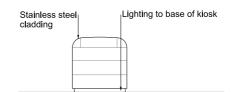


Shaft structure kiosk North elevation

structure


Interception

Scale 1:50

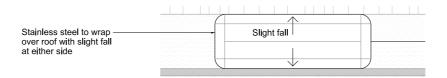

Shaft structure kiosk roof plan

Scale 1:50

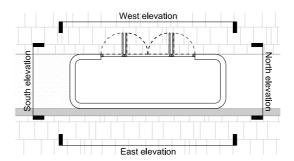

Shaft structure kiosk plan

Scale 1:50

Mapping reproduced by permission of Ordnance Survey on behalf of HMSO. © Crown Copyright and Database right 2012. All rights reserved. Ordance Survey licence number 100019345

Keyplan:

Coordinates are to be Ordance Survey Datum OSGB36. All levels are in metres and relate to the Tunnel Datum which is 100 metres below Ordnance Datum Newlyn.

Notes:

1. All dimensions and levels are approximate.



INDICATIVE

Scale 1:50 at A1

1:100 if reproduced at A3

Location

Albert Embankment Foreshore London Borough of Lambeth

Document Information

Application for Development Consent


Kiosk design intent

Book of plans - section 17 DCO-PP-15X-ALBEF-170026 January 2013








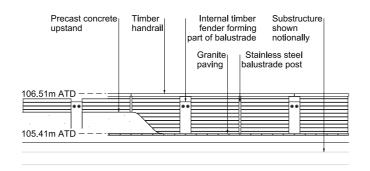

East elevation

Scale 1:50

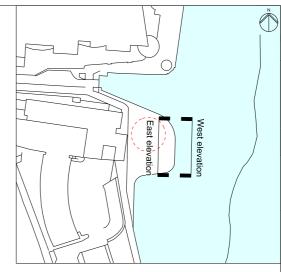


Mapping reproduced by permission of Ordnance Survey on behalf of HMSO. © Crown Copyright and Database right 2012. All rights reserved. Ordance Survey licence number 100019345

Keyplan:

Coordinates are to be Ordance Survey Datum OSGB36, All levels are in metres and relate to the Tunnel Datum which is 100 metres below Ordnance Datum Newlyn.


Notes:

1. All dimensions and levels are approximate.

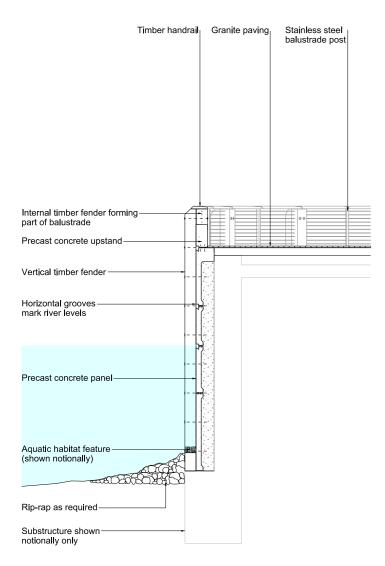


Detail section

Scale 1:50

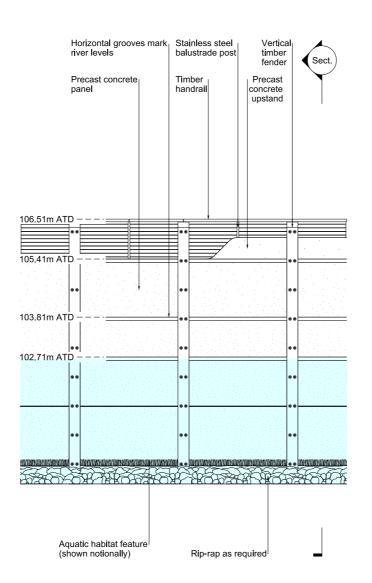

West elevation

Scale 1:50

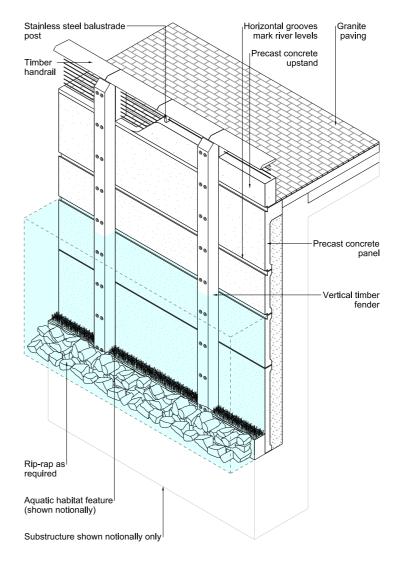

Isometric

NTS



INDICATIVE

Locatio

Albert Embankment Foreshore London Borough of Lambeth

Document Information


Application for Development Consent


Typical river wall design intent

Book of plans - section 17 DCO-PP-15X-ALBEF-170027 January 2013





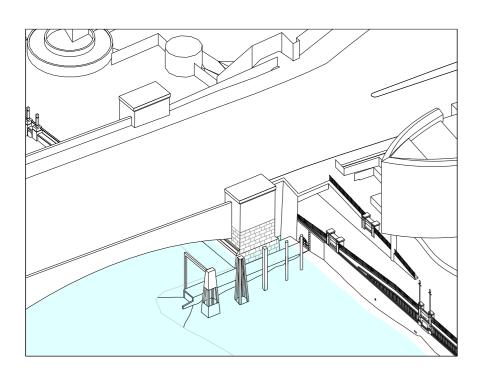

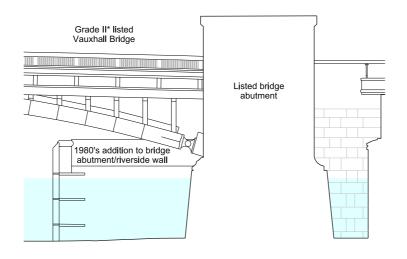

Keyplan:

This drawing

Coordinates are to be Ordance Survey Datum OSGB36. All levels are in metres and relate to the Tunnel Datum which is 100 metres below Ordnance Datum Newlyn.

Notes:


1. All dimensions and levels are approximate.
 2. Drawing is based on as-constructed drawings and topographical survey and not on heritage survey.

Isometric

Scale NTS


Bridge abutment section

Scale 1:100

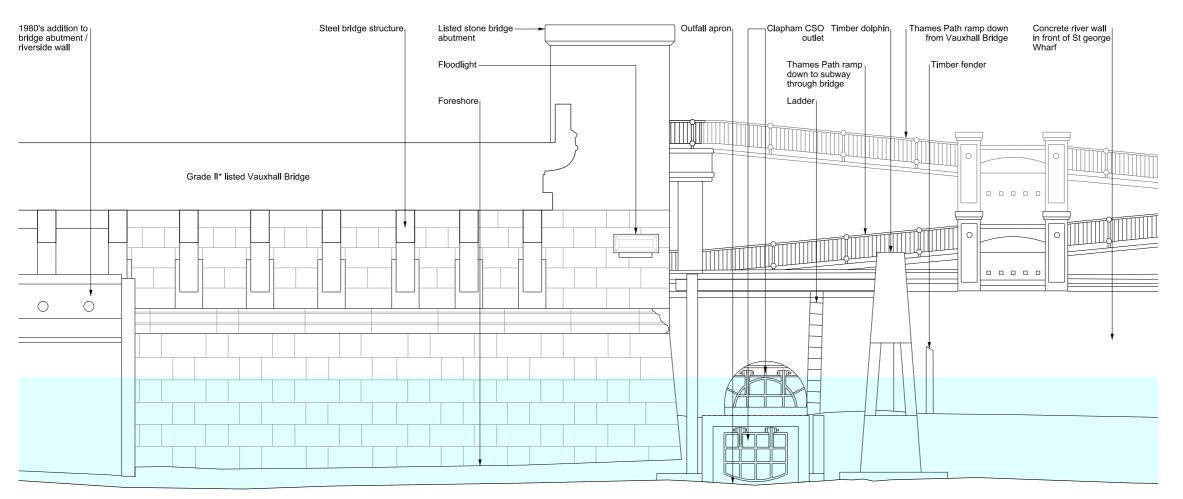

River elevation

Scale 1:50

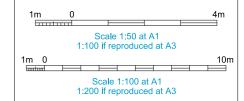

FOR INFORMATION

Locatio

Albert Embankment Foreshore London Borough of Lambeth

Document Information


Application for Development Consent


As existing listed structure interface -Interception structure Book of plans - section 17 DCO-PP-15X-ALBEF-170028





January 2013

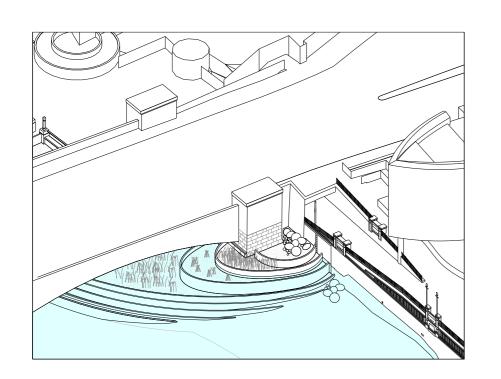

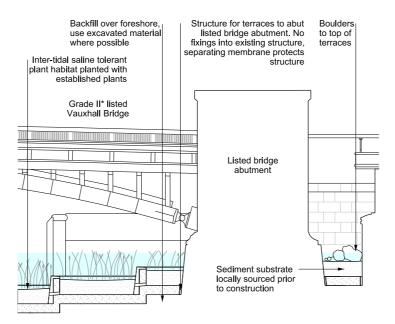

Keyplan:

This drawing

Coordinates are to be Ordance Survey Datum OSGB36. All levels are in metres and relate to the Tunnel Datum which is 100 metres below Ordnance Datum Newlyn.


Notes:

All dimensions and levels are approximate.
 Drawing is based on as-constructed drawings and topographical survey and not on heritage survey.
 Navigational signs to be fixed to bridge in accordance with PLA requirements.

Isometric Scale NTS


Bridge abutment section

Scale 1:100

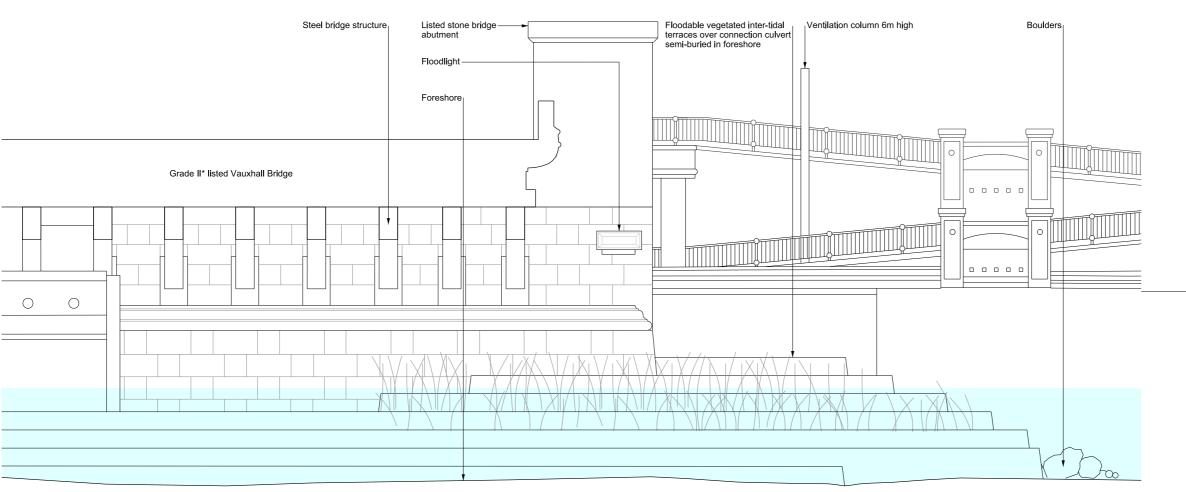

River elevation

Scale 1:50

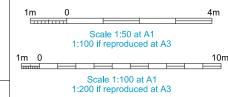

INDICATIVE

Location

Albert Embankment Foreshore London Borough of Lambeth

Document Information


Application for Development Consent


Proposed listed structure interface -Interception structure Book of plans - section 17 DCO-PP-15X-ALBEF-170029








January 2013

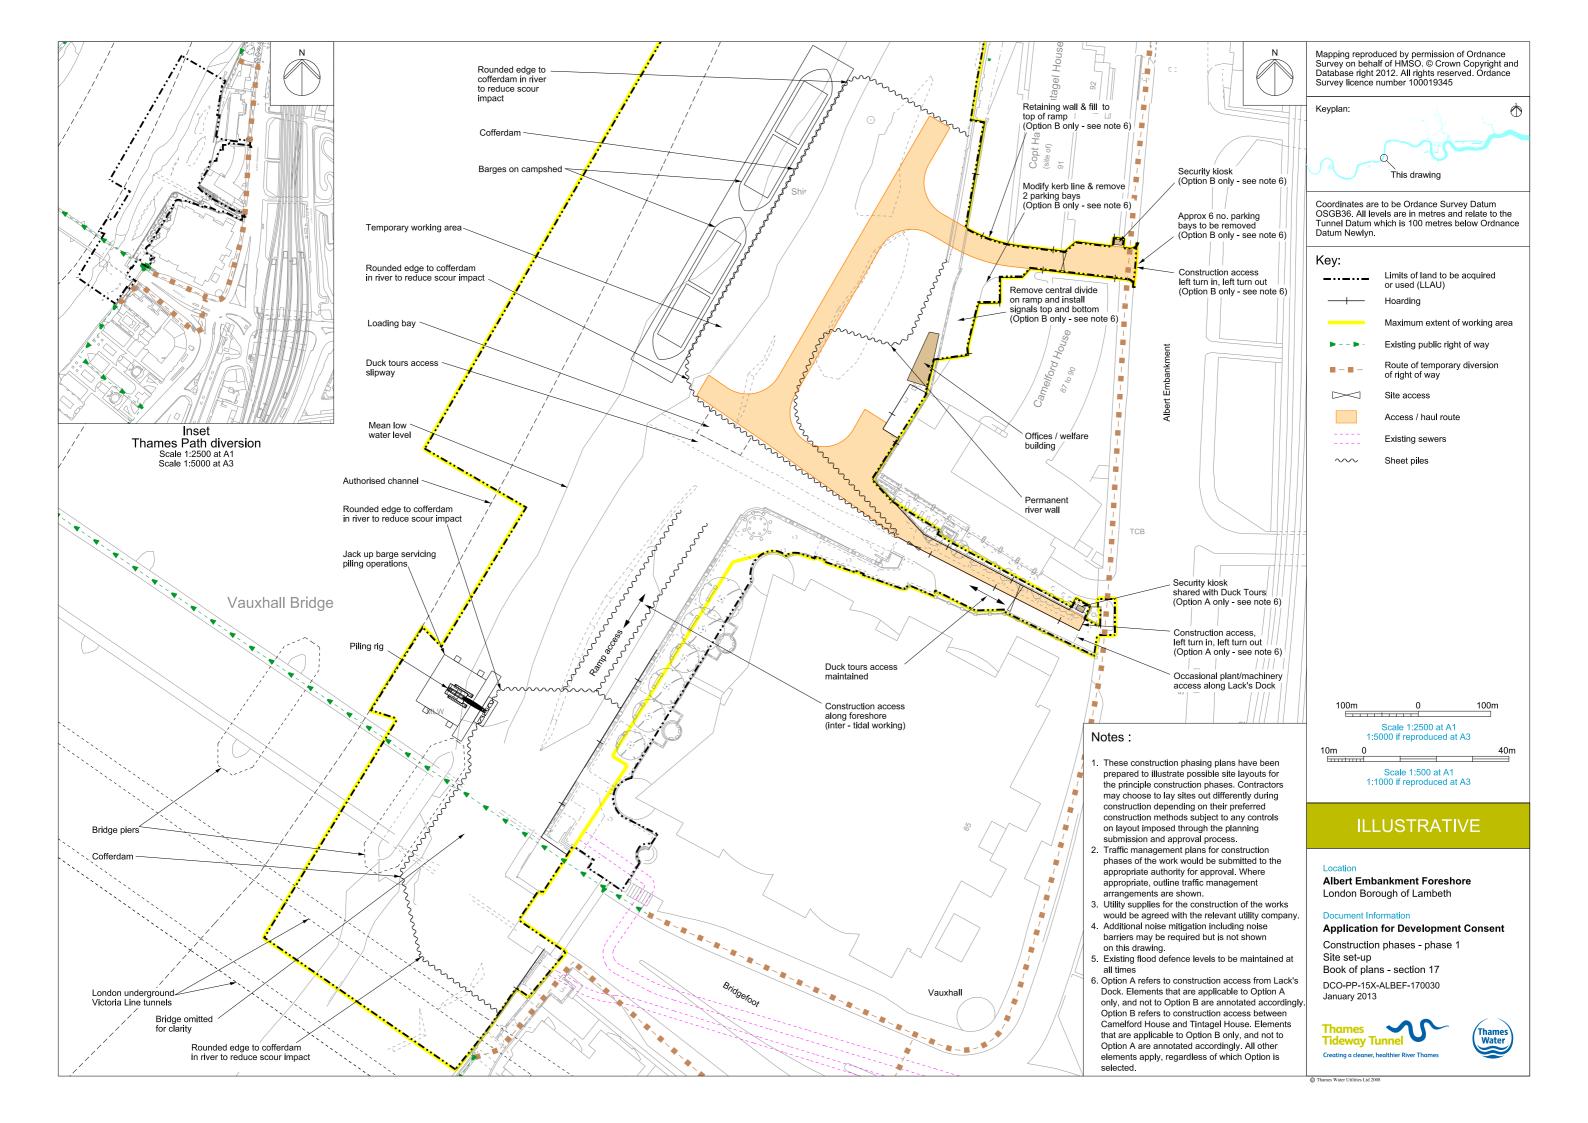


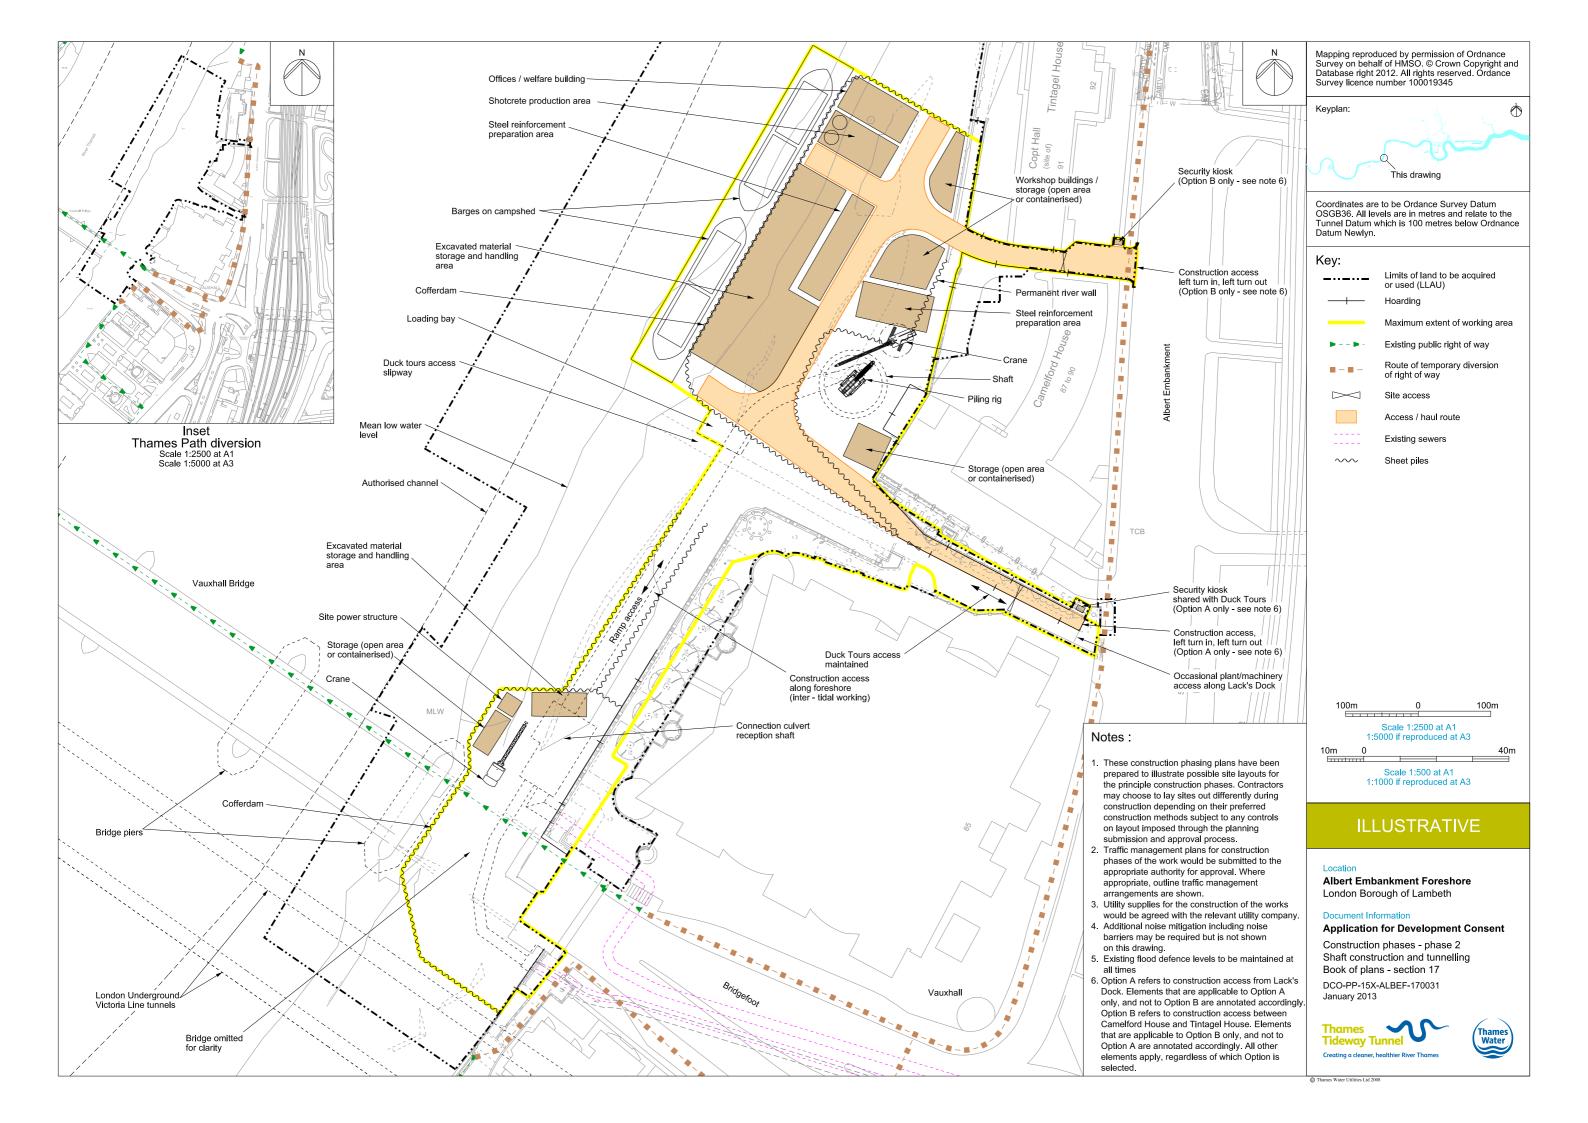


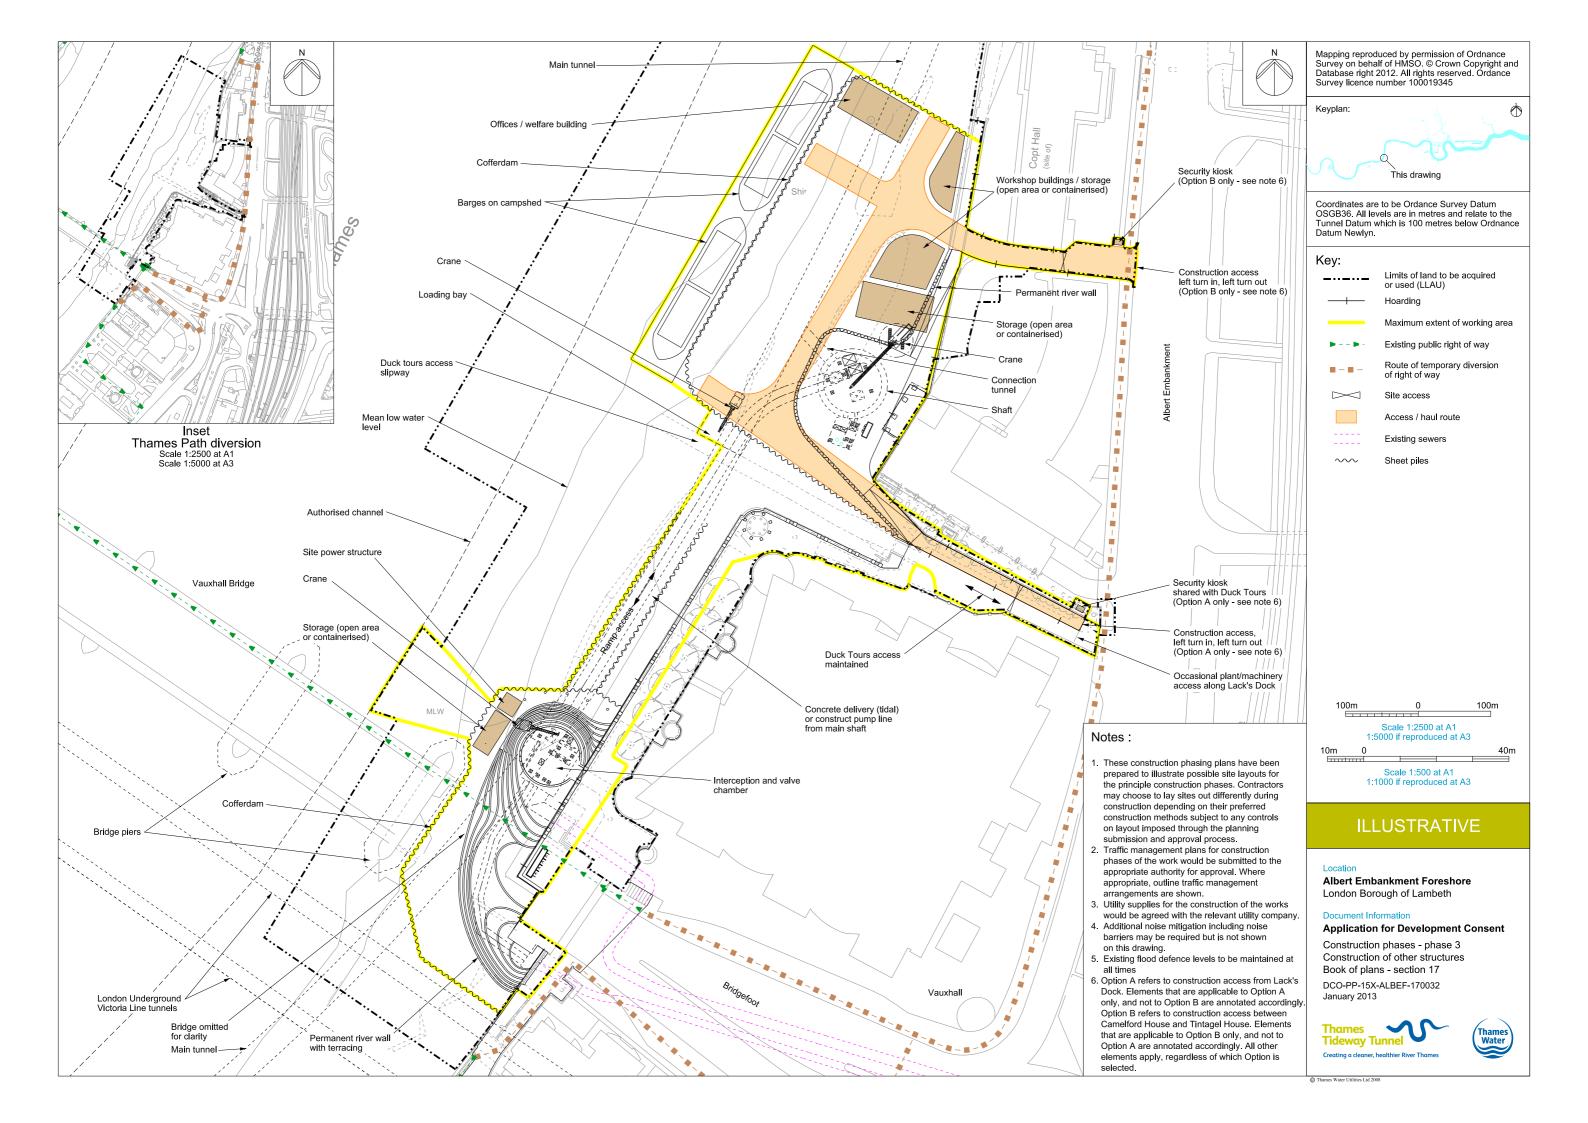


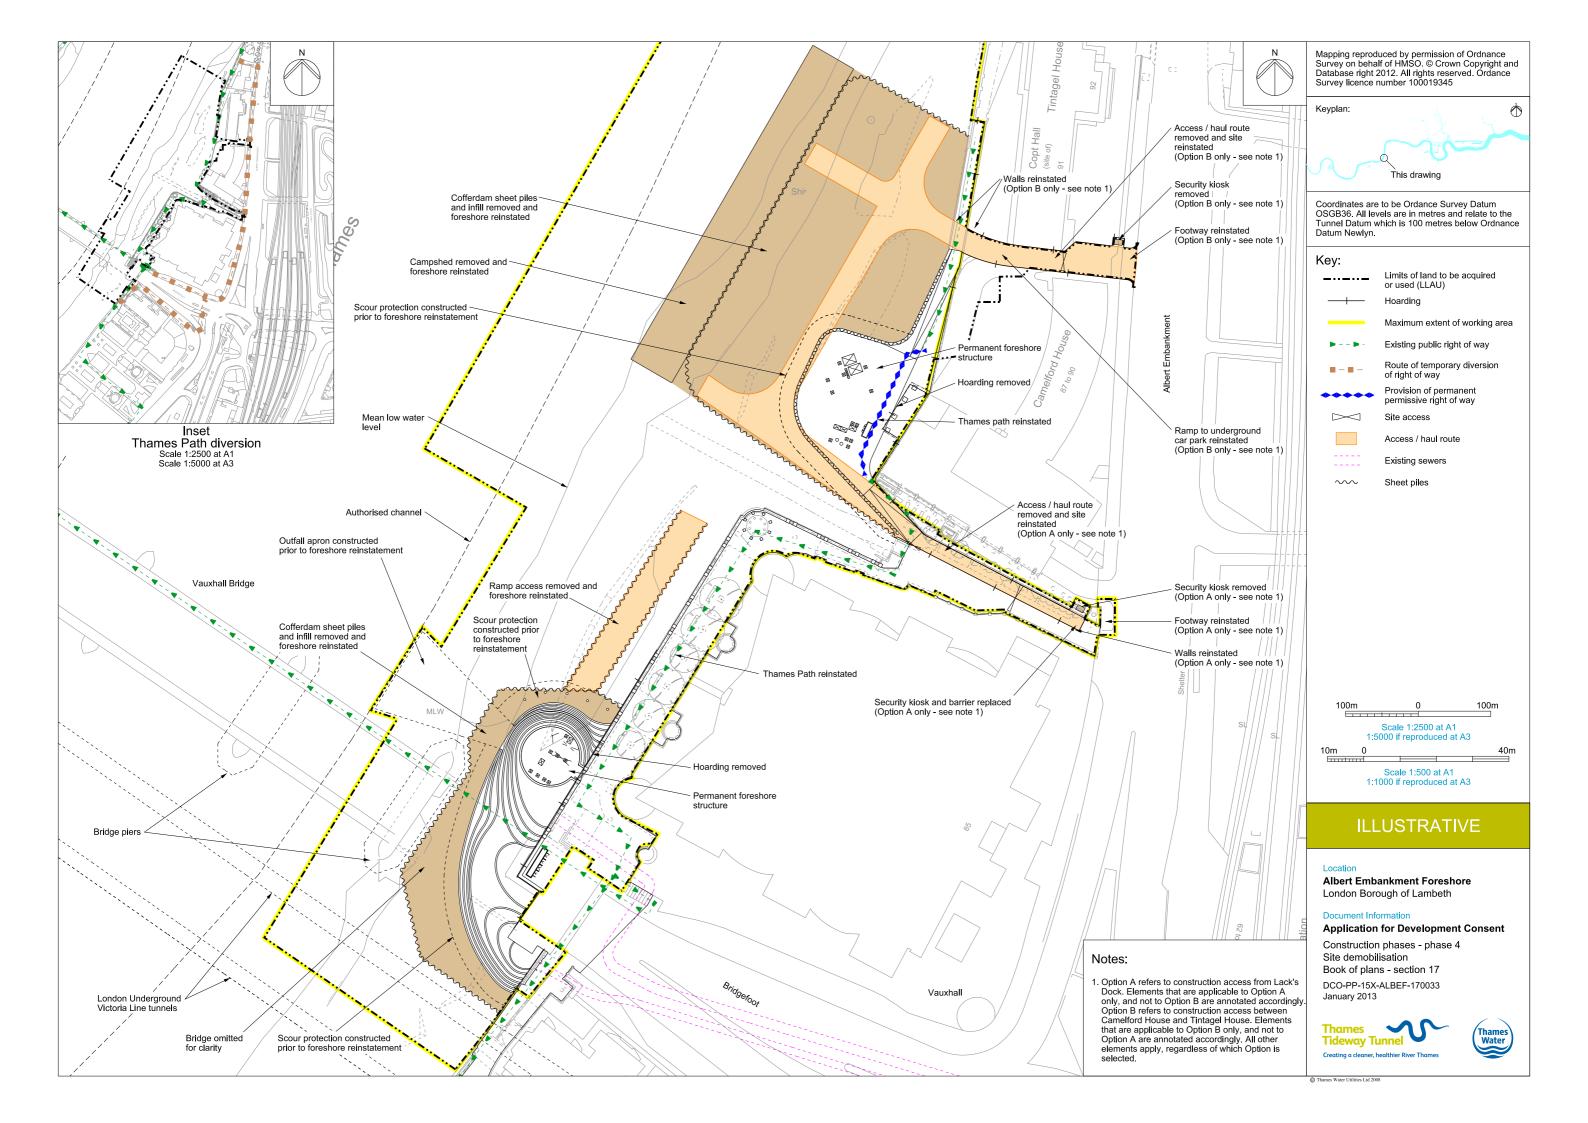

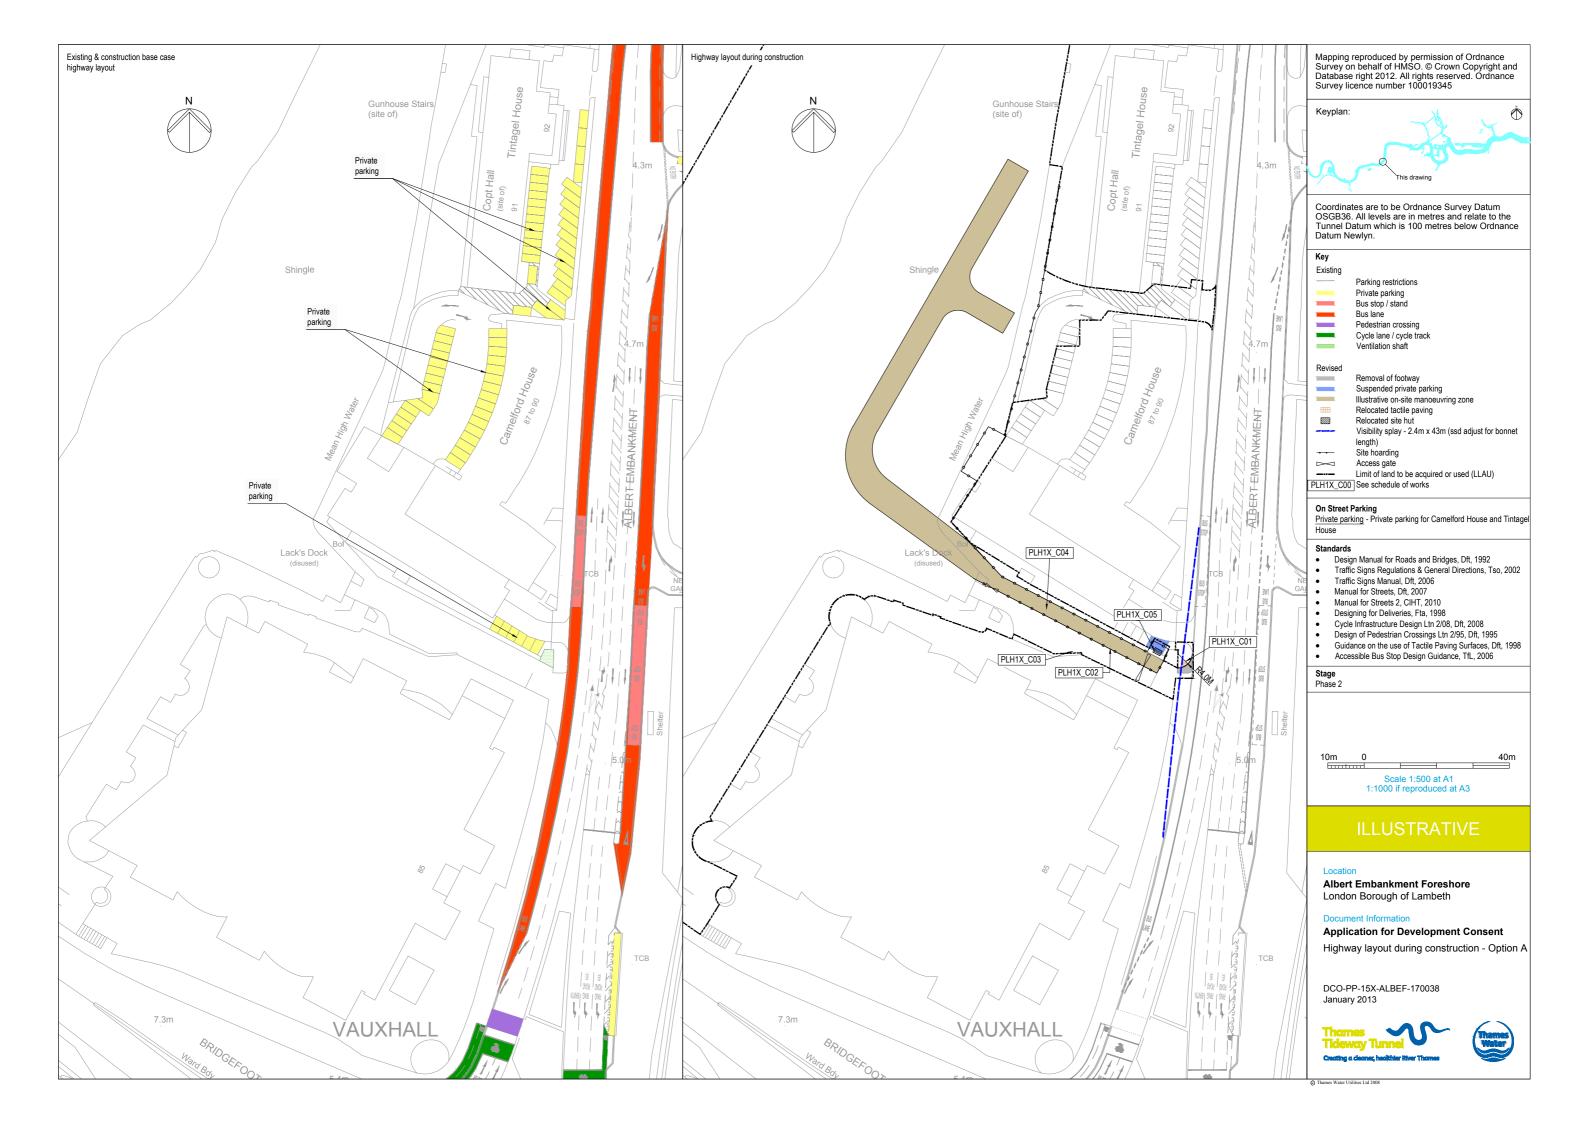

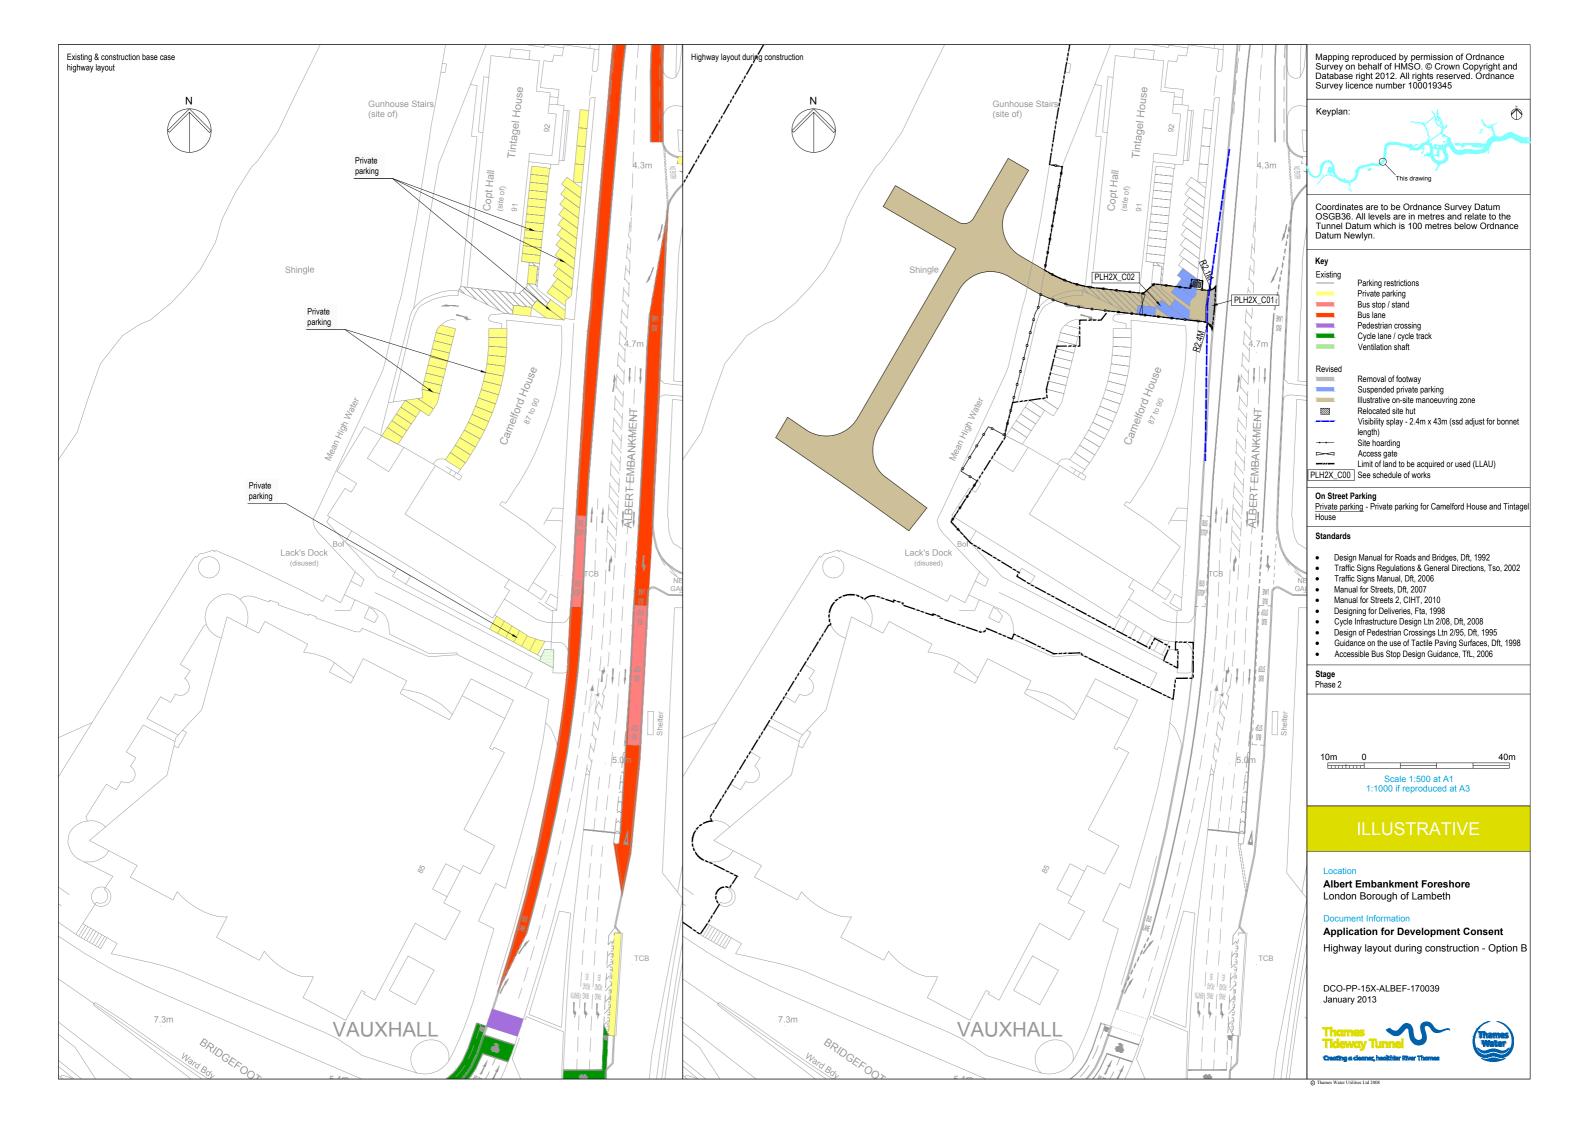

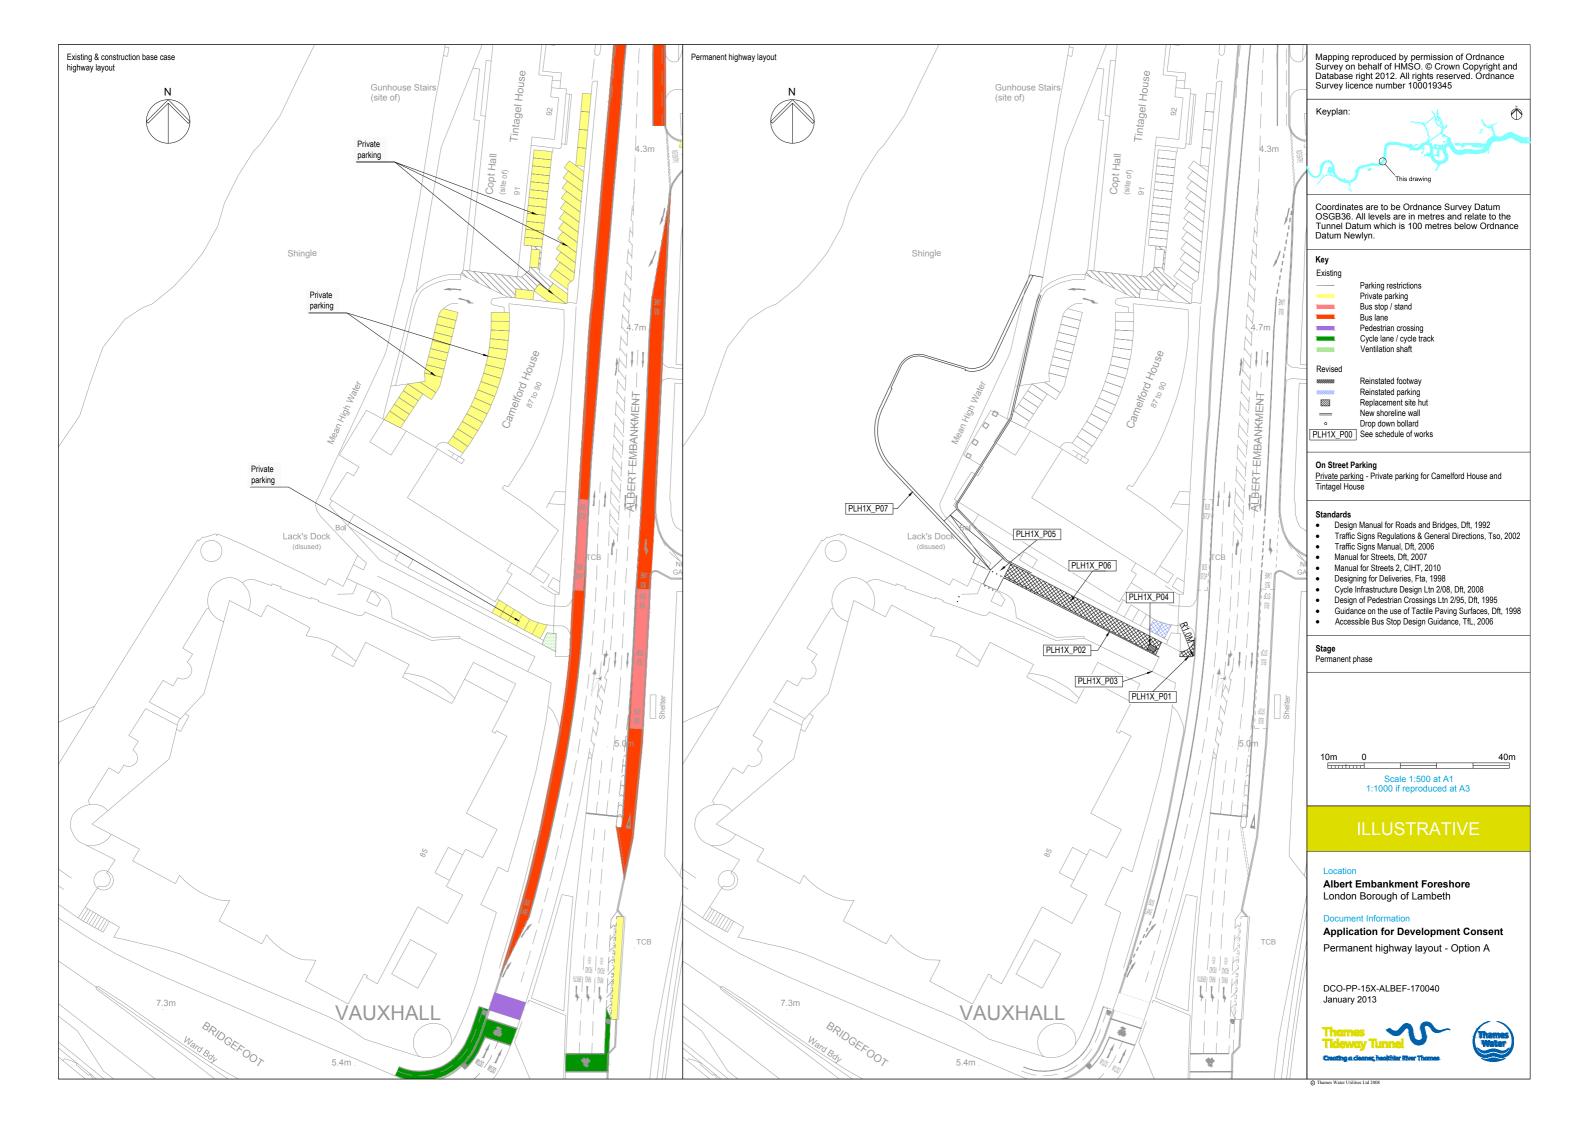

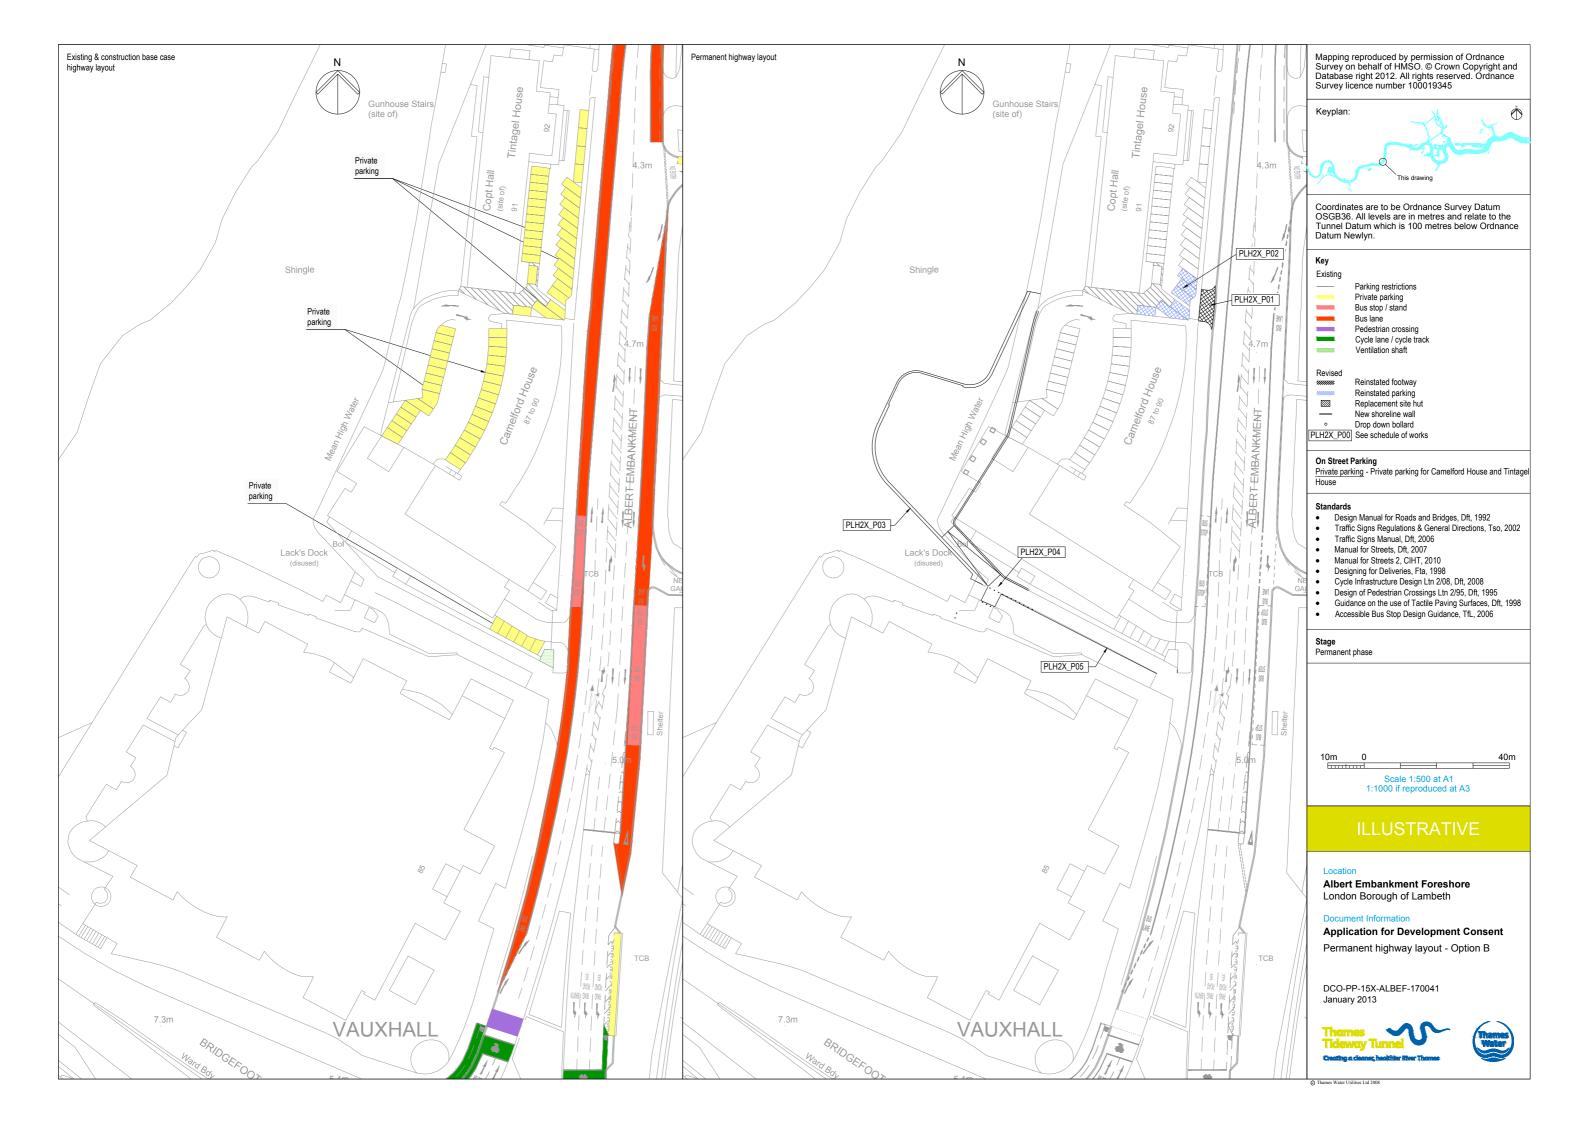

Copyright notice

Copyright © Thames Water Utilities Limited January 2013. All rights reserved.

Any plans, drawings, designs and materials (materials) submitted by Thames Water Utilities Limited (Thames Water) as part of this application for Development Consent to the Planning Inspectorate are protected by copyright. You may only use this material (including making copies of it) in order to (a) inspect those plans, drawings, designs and materials at a more convenient time or place; or (b) to facilitate the exercise of a right to participate in the pre-examination or examination stages of the application which is available under the Planning Act 2008 and related regulations. Use for any other purpose is prohibited and further copies must not be made without the prior written consent of Thames Water.

Thames Water Utilities Limited

Clearwater Court, Vastern Road, Reading RG1 8DB

The Thames Water logo and Thames Tideway Tunnel logo are © Thames Water Utilities Limited. All rights reserved.

